DEVELOPMENT NO.:	24027220
APPLICANT:	Michael Velonakis
ADDRESS:	31 Crescent Drive, Norton Summit
NATURE OF DEVELOPMENT:	Variation to Development Authorisation 21027228 - addition of two (2) balconies to building for tourist accommodation and studio workshop
ZONING INFORMATION:	Zones:  Productive Rural Landscape Subzones:  N/A Overlays:  Environment and Food Production Area  Hazards (Bushfire - High Risk)  Hazards (Flooding - Evidence Required)  Heritage Adjacency  Limited Land Division  Native Vegetation  Prescribed Wells Area  Traffic Generating Development  Urban Transport Routes Technical Numeric Variations (TNVs):
LODGEMENT DATE:	13 September 2024
RELEVANT AUTHORITY:	Assessment Panel at Adelaide Hills Council
PLANNING & DESIGN CODE VERSION:	2024.17
CATEGORY OF DEVELOPMENT:	Code Assessed – Performance Assessed
NOTIFICATION:	No
RECOMMENDING OFFICER:	Sebastien Paraskevopoulos
REFERRALS STATUTORY:	Nil
REFERRALS NON-STATUTORY:	Nil

# **CONTENTS:**

ATTACHMENT 1: Application Documents ATTACHMENT 3: Zoning Map

ATTACHMENT 2: Subject Land Map ATTACHMENT 4: Relevant P & D Code Policies

# **DETAILED DESCRIPTION OF PROPOSAL:**

The application seeks to modify the approved tourist accommodation and studio workshop building to include two balconies. This building is currently under construction.

The balconies are proposed to the northern and eastern aspects of the building and would both be accessible from the family room on the upper level. The northern balcony has a floor area of 18.66m2 and the southeastern balcony has a floor area of 15.73m2, while each would be a maximum of 2.8m above the ground floor level of the building.

Other minor changes include the addition of a door and window to the northern upper level of the building, to facilitate access and improve the vantage to the north balcony. Similarly, an additional door is proposed to access the east balcony.

All other aspects of the building would remain as previously approved. The includes the site location and setbacks, floor plan (no increase to internal habitable area) and external finishes, and extends to the operational details conditioned.

#### **BACKGROUND:**

The land has been subject to three approved developments since 2017. The retaining walls and associated earthworks approved in Development Application 18/1035/473 provided a level site for the subject building. Stage two of Development Application 15/517/473 was altered by the most recent application following the installation of the foundations and slab. The building for tourist accommodation and studio workshop approved in Development Application 21027228 is currently under construction.

In 2016 the address of the subject land was changed from 6 Crescent Drive to 31 Crescent Drive.

APPROVAL DATE	APPLICATION NUMBER	DESCRIPTION OF PROPOSAL	
5 December 2023	21027228	Partial change of use of existing dwelling to include tourist accommodation and construction of building for tourist accommodation and studio workshop	
2 April 2020	18/1035/473	Retaining walls (maximum height 3m) and combined fence and retaining wall (3.6m) & associated earthworks	
LAPSED	18/338/473	Verandah (freestanding) over existing swimming pool	
6 October 2017	15/517/473	Staged development – Stage One - dwelling alterations & additions & deck (maximum height 2.5m), Stage Two - demolition of shed & construction of studio/workshop with associated earthworks	

# **SUBJECT LAND & LOCALITY:**

**Location reference:** 31 Crescent Drive, Norton Summit SA 5136 **Title ref.:** CT: 6196/807 **Plan Parcel:** Lot 10 Sec: P1079 DP:115375

**Site Description:** 

The allotment is regularly shaped with a total site area of 3643m<sup>2</sup>. It is one of six allotments in the locality which share street frontages to both Crescent Drive and Lobethal Road.

In addition to the building currently under construction, the land also features the main dwelling, and an associated swimming pool, deck and verandah. These existing elements are located centrally between the front and rear property

boundaries but favour the west side boundary.

The topography of the land descends from Crescent Drive to Lobethal Road (south to north), at a gradient of approximately 1:5. The floor level of the existing dwelling is 4.6m below the lower floor level of the building under

construction.

The land is served by one existing vehicle access point, located off Crescent Drive near the south-most corner of the

allotment.

The land is not connected to SA Water or Sewer Mains and has an approved on-site waste system. The land is not

subject to any easements or rights of way.

Locality

The property is located between Lobethal Road to the north, and Crescent Drive to the south, within the Productive

Rural Landscape Zone.

This area is characterised by moderate to large rural living allotments with several large horticulture properties located throughout. These include a vineyard to the north of the subject land and the State Heritage listed Grove Hill estate

to the south, which is South Australia's oldest orchard in continuous operation.

Norton Summit Primary School is situated further up Crescent Drive to the east, while a range of non-residential uses (including a church, hotel, medical clinic, post office, CFS station, and the Adelaide Hills Council Summit Community Centre) are located to the north-east, clustered around the five-way intersection of Norton Summit Road, Old Norton

Summit Road, Lobethal Road, Debneys Road, and Colonial Drive.

**CONSENT TYPE REQUIRED:** 

**Planning Consent** 

**CATEGORY OF DEVELOPMENT:** 

• PER ELEMENT:

Balcony/Deck: Code Assessed - Performance Assessed

• OVERALL APPLICATION CATEGORY:

Code Assessed – Performance Assessed

REASON

The Planning and Design Code provides no 'Accepted' or 'Deemed to Satisfy' pathway for the above element –nor is it categorised as 'Restricted' under Table 4 of the zone. Therefore, as per sections 105 (b) and 107 of the *Planning Development & Infrastructure Act 2016*, the development is categorised as Code Assessed – Performance

Assessed.

### **PUBLIC NOTIFICATION**

No

### REASON

Balconies (decks) are exempt from public notification as per table 5 item 2 (f) of the Productive Rural Landscape Zone. No Column B exceptions are listed.

#### PLANNING ASSESSMENT

#### **Desired outcomes**

Desired outcomes are policies designed to aid the interpretation of performance outcomes by setting a general policy agenda for a zone, subzone, overlay or general development policies module. Where a relevant authority is uncertain as to whether or how a performance outcome applies to a development, the desired outcome(s) may inform its consideration of the relevance and application of a performance outcome, or assist in assessing the merits of the development against the applicable performance outcomes collectively.

#### Performance outcomes

Performance outcomes are policies designed to facilitate assessment according to specified factors, including land use, site dimensions and land division, built form, character and hazard risk minimisation.

### Designated performance features

In order to assist a relevant authority to interpret the performance outcomes, in some cases the policy includes a standard outcome which will generally meet the corresponding performance outcome (a designated performance feature or DPF). A DPF provides a guide to a relevant authority as to what is generally considered to satisfy the corresponding performance outcome but does not need to necessarily be satisfied to meet the performance outcome, and does not derogate from the discretion to determine that the outcome is met in another way, or from the need to assess development on its merits against all relevant policies.

A detailed assessment of the application has taken place against the relevant provisions of the Planning and Design Code (P & D Code) and this is provided below under a series of headings. A Policy Enquiry extract containing the relevant provisions of the P & D Code is contained in **Attachment 6 – Relevant P & D Code Policies**.

# **Productive Rural Landscape Zone**

Desired Outcomes	
	A diverse range of land uses at an appropriate scale and intensity that capitalise on the
DO 1	region's proximity to the metropolitan area and the tourist and lifestyle opportunities
001	this presents while also conserving the natural and rural character, identity, biodiversity
	and sensitive environmental areas and scenic qualities of the landscape.
	A zone that promotes agriculture, horticulture, value adding opportunities, farm gate
DO 2	businesses, the sale and consumption of agricultural based products, tourist
002	development and accommodation that expands the economic base and promotes its
	regional identity.
DO 3	The creation of local conditions that support new and continuing investment while
DO 3	seeking to promote co-existence with adjoining activities and mitigate land use conflicts.
Performance Outcomes (PO) & Deemed to Satisfy (DTS)/Designated Performance Feature (DPF) criteria	
PO 2.2 & DPF 2.2	

The subject building was approved under version 2021.14 of the Planning and Design Code. In version 2024.17, the Desired Outcomes remain the same, and the proposed balconies are not considered to alter the approved building's performance against them nor conflict in their own right.

PO 2.2, which directs the siting of buildings with regarding to gradient and earthworks, is not relevant to this assessment. The building is already under construction in the approved location, with the proposed balcony additions not altering earthworks.

# **Overlays**

# **Environment and Food Production Area Overlay**

Desired Outcomes	
DO 1	Protection of valuable rural, landscape, environmental and food production areas from urban encroachment.
Performance Outcome (PO) and Designated Performance Feature (DPF) criteria	
N/A	

This overlay concerns urban encroachment and seeks to ensure land division is undertaken in accordance with Section 7 of the *Planning, Development and Infrastructure Act 2016*. This is not applicable to the proposal.

## Hazards (Bushfire - High Risk) Overlay

Desired Outcomes	
	Development, including land division is sited and designed to minimise the threat and impact of
	bushfires on life and property with regard to the following risks:
	(a) potential for uncontrolled bushfire events taking into account the increased frequency and
DO 1	intensity of bushfires as a result of climate change
DO 1	(b) high levels and exposure to ember attack
	(c) impact from burning debris
	(d) radiant heat
	(e) likelihood and direct exposure to flames from a fire front.
DO 2	Activities that increase the number of people living and working in the area or where evacuation
DO 2	would be difficult is sited away from areas of unacceptable bushfire risk.
DO 3	To facilitate access for emergency service vehicles to aid the protection of lives and assets from
DO 3	bushfire danger.
Performance Outcome (PO) and Designated Performance Feature (DPF) criteria	
PO 1.1; PO 2.1; PO 3.1; PO 3.2 & DPF 3.2	

As part of the original assessment of the building itself, referral to the Country Fire Service was undertaken. The Country Fire Service had no objections to the proposal. Conditions relating to firefighting vehicle manoeuvring, water supply and access, and asset protection zones were stipulated.

As an element, balconies do not trigger referral to the CFS. As a variation to the approved building and use, they are not substantial, and do not change the essential nature of the development. The balconies would not increase the potential for fire outbreak as a result of the spontaneous combustion of materials, spark generation or through the magnification or reflection of light. Their inclusion does not alter the building in a way which would increase the potential for trapping burning debris against or underneath the building or structure. The relevant Performance Outcomes are not conflicted by the proposal.

# **Hazards (Flooding - Evidence Required)**

Desired Outcomes	
DO 1	Development adopts a precautionary approach to mitigate potential impacts on people, property, infrastructure and the environment from potential flood risk through the appropriate siting and design of development.
Performance Outcome (PO) and Designated Performance Feature (DPF) criteria	
N/A	

Owing to the topography of Norton Summit, there is no flood mapping in proximity of the subject land or the greater locality.

# **Heritage Adjacency**

Desired Outcomes		
DO 1	Development adjacent to State and Local Heritage Places maintains the heritage and cultural values of	
DO 1	those Places.	
Performance Outcome (PO) and Designated Performance Feature (DPF) criteria		
N/A	N/A	

The subject land adjoins 412 Old Norton Summit Road, which contains the State Heritage listed Grove Hill estate. This listing includes several buildings, described by the SA Heritage Places Database as 'Dwelling ('Grove Hill'), including Coach House, Stables, 3 Hole Privy, Gatehouse, Fruit Store, Cider Cellars and Hothouses'.

The site area of the approved building is over 500m from the nearest building on the adjoining land and separated by Crescent Drive. The proposed variations are not considered to impact the heritage context of the adjacent land.

# **Limited Land Division Overlay**

Desired Outcomes	
DO 1	The long term use of land for primary production is maintained by minimising fragmentation through division of land.
Performance Outcome (PO) and Designated Performance Feature (DPF) criteria	
N/A	

This overlay pertains to land division and is not applicable to the proposal.

# **Native Vegetation**

Desired Outcomes	
DO 1	Areas of native vegetation are protected, retained and restored in order to sustain biodiversity, threatened species and vegetation communities, fauna habitat, ecosystems services, carbon storage and amenity values.
Performance Outcome (PO) and Designated Performance Feature (DPF) criteria	
PO 1.1 & DPF 1.1	

No native vegetation would be impacted by the variation, and the applicant made their declaration upon submission of the application, which complies with DTS/DPF1.1

# **Prescribed Wells Area Overlay**

Desired Outcomes	
DO 1	Sustainable water use in prescribed wells areas.
Performance Outcome (PO) and Designated Performance Feature (DPF) criteria	
N/A	

The proposal would not result in the taking of additional water for which a licence would be required under the Landscape South Australia Act 2019, which aligns with PO 1.1.

### **Urban Transport Routes**

Desired	Desired Outcomes		
DO 1	Safe and efficient operation of Urban Transport Routes for all road users.		
DO 2	Provision of safe and efficient access to and from Urban Transport Routes.		
Performance Outcome (PO) and Designated Performance Feature (DPF) criteria			
N/A	N/A		

The proposal does not include any new vehicle access points, nor the alteration or re-location of the existing access used to service the development. State-owned Lobethal Road will not be altered or directly impacted by the proposal.

# **General Development Policies**

### **Clearance from Overhead Powerlines**

Desired Outcomes	
DO 1	Protection of human health and safety when undertaking development in the vicinity of overhead
	transmission powerlines.
Performance Outcome (PO) and Designated Performance Feature (DPF) criteria	
PO 1.1 & DPF 1.1	

A declaration was made by the applicant upon submission of the application that the proposal would not be contrary to the regulations prescribed for the purposes of section 86 of the Electricity Act 1996. On this basis the proposal is in accordance with the above provisions.

# Design

Desired O	Desired Outcomes		
	Development is:		
DO 4	(a) contextual - by considering, recognising and carefully responding to its natural surroundings or built environment and positively contributing to the character of the immediate area		
DO <b>1</b>	(b) durable - fit for purpose, adaptable and long lasting		
	(c) inclusive - by integrating landscape design to optimise pedestrian and cyclist usability, privacy		
	and equitable access and promoting the provision of quality spaces integrated with the public		

- realm that can be used for access and recreation and help optimise security and safety both internally and within the public realm, for occupants and visitors
- (d) sustainable by integrating sustainable techniques into the design and siting of development and landscaping to improve community health, urban heat, water management, environmental performance, biodiversity and local amenity and to minimise energy consumption.

### Performance Outcome (PO) and Designated Performance Feature (DPF) criteria

PO 8.1 & DPF 8.1; PO 33.1 & DPF 33.1; PO 33.2 & DPF 33.2; PO 33.3 & DPF 33.3;

The development does not propose any excavation or filling of land or other works which would disturb the natural topography. PO 8.1 is therefore not applicable.

The balconies do not increase the building footprint or the internal habitable area of the approved building. They retain the existing setbacks, and are an adequate distance from the subject land's north, east, and south boundaries of which they view. On this basis, the balconies comply with PO 33.1.

The balconies do not present direct overlooking of habitable rooms or private open space of neighbouring 37 Crescent Drive (the allotment abutting east). The Planning and Design Code defines *direct overlooking* as limited to an area that falls within a horizontal distance of 15 metres measured from any point of the overlooking deck, balcony or terrace. See illustration below:

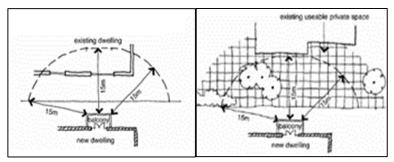


Figure 1: Extract from Planning and Design Code illustrating direct overlooking from deck, balcony, or terrace

The proposal therefore is not obliged to include any methods of screening and is considered to meet PO 33.2.

The variation to include the balconies does not alter the maximum number of guests able to use the building as tourists, and as such the development would remain compliant with Table 1 – General Off-Street Car Parking Requirements of the Planning & Design Code. This satisfies PO 33.3

#### Infrastructure and Renewable Energy Facilities

Desired 0	Desired Outcomes		
DO 1	Efficient provision of infrastructure networks and services, renewable energy facilities and ancillary development in a manner that minimises hazard, is environmentally and culturally sensitive and manages adverse visual impacts on natural and rural landscapes and residential amenity.		
Performa	nce Outcome (PO) and Designated Performance Feature (DPF) criteria		
PO 11.1 8	PO 11.1 & DPF 11.1; PO 12.1 & DPF 12.1; PO 12.2 & DPF 12.2		

The proposed building works would not encroach upon the approved septic system, satisfying PO 12.2.

### **CONSIDERATION OF SERIOUSLY AT VARIANCE**

The proposal is not considered to be seriously at variance with the provisions of the Planning & Design Code.

Balconies are a common form of ancillary development, and together with decks are found throughout the Productive Rural Landscape Zone and the greater Council district. The balconies proposed in this application are of a modest scale which do not increase the footprint or height of the approved building, nor do they present any direct overlooking which ought to be mitigated. The proposal accords with all relevant polices from the Zone, Overlay, and General Development Polices sections.

#### **CONCLUSION**

The proposal is for a variation to Development Authorisation 21027228, to add two balconies to the building approved for tourist accommodation and studio workshop. The subject land is located within the Productive Rural Landscape Zone, in a locality of large rural living allotments with several large horticulture properties located throughout.

The application does not propose to vary any of the operational details which were conditioned as part of the original Development Authorisation. The proposed variations would not change the essential nature of the approved building and are not substantial by the fact the building's original approved footprint, internal habitable area, and wall and building heights are retained.

The proposal is not considered to be seriously at variance with any of the applicable policies of the Planning & Design Code, adequately addressing all relevant Zone, Overlays, and General Development provisions.

# **RECOMMENDATION**

It is recommended that the Council Assessment Panel resolve that:

- 1) Pursuant to Section 107(2)(c) of the Planning, Development and Infrastructure Act 2016, and having undertaken an assessment of the application against the Planning and Design Code, the application is NOT seriously at variance with the provisions of the Planning and Design Code; and
- 2) Development Application Number 24011855 Demetrios Diamanti for a Variation to Development Authorisation 21027228 - addition of two (2) balconies to building for tourist accommodation and studio workshop at 31 Crescent Drive, Norton Summit is GRANTED Planning Consent subject to the following conditions:

#### **CONDITIONS**

### **Planning Consent**

- 1) The development granted shall be undertaken and completed in accordance with the stamped plans and documentation, except where varied by conditions below.
- 2) Except where varied by this authorisation, all other conditions, plans and details relating to Development Authorisation 21027228 continue to apply to this amended authorisation.

#### **ADVISORY NOTES**

#### **General Notes**

- No work can commence on this development unless a Development Approval has been obtained. If one or more consents have been granted on this Decision Notification Form, you must not start any site works or building work or change of use of the land until you have received notification that Development Approval has been granted.
- 2) Appeal rights General rights of review and appeal exist in relation to any assessment, request, direction or act of a relevant authority in relation to the determination of this application, including conditions.
- 3) This Planning Consent is valid for a period of twenty-four (24) months commencing from the date of the decision, subject to the below or subject to an extension having been granted by the relevant authority. If applicable, Building Consent must be obtained prior to expiration of the Planning Consent.
- 4) Where an approved development has been substantially commenced within 2 years from the operative date of approval, the approval will then lapse 3 years from the operative date of the approval (unless the development has been substantially or fully completed within those 3 years, in which case the approval will not lapse).

## OFFICER MAKING RECOMMENDATION

Name: Sebastien Paraskevopoulos

Title: Statutory Planner



Product
Date/Time
Customer Reference
Order ID

Register Search (CT 6196/807) 10/09/2021 11:37AM NOrton Summit 20210910004223

REAL PROPERTY ACT, 1886



The Registrar-General certifies that this Title Register Search displays the records maintained in the Register Book and other notations at the time of searching.



# Certificate of Title - Volume 6196 Folio 807

Parent Title(s) CT 5081/167

Creating Dealing(s) RTD 12735138

**Title Issued** 15/09/2017 **Edition** 1 **Edition Issued** 15/09/2017

# **Estate Type**

**FEE SIMPLE** 

# **Registered Proprietor**

MANI WHITE
OF 6 CRESCENT DRIVE NORTON SUMMIT SA 5136

# **Description of Land**

ALLOTMENT 10 DEPOSITED PLAN 115375 IN THE AREA NAMED NORTON SUMMIT HUNDRED OF ADELAIDE

# **Easements**

NIL

# **Schedule of Dealings**

Dealing Number Description

11564584 MORTGAGE TO AUSTRALIA & NEW ZEALAND BANKING GROUP LTD.

# **Notations**

Dealings Affecting Title NIL


Priority Notices NIL

Notations on Plan NIL

Registrar-General's Notes NIL

Administrative Interests NIL

Land Services SA Page 1 of 1

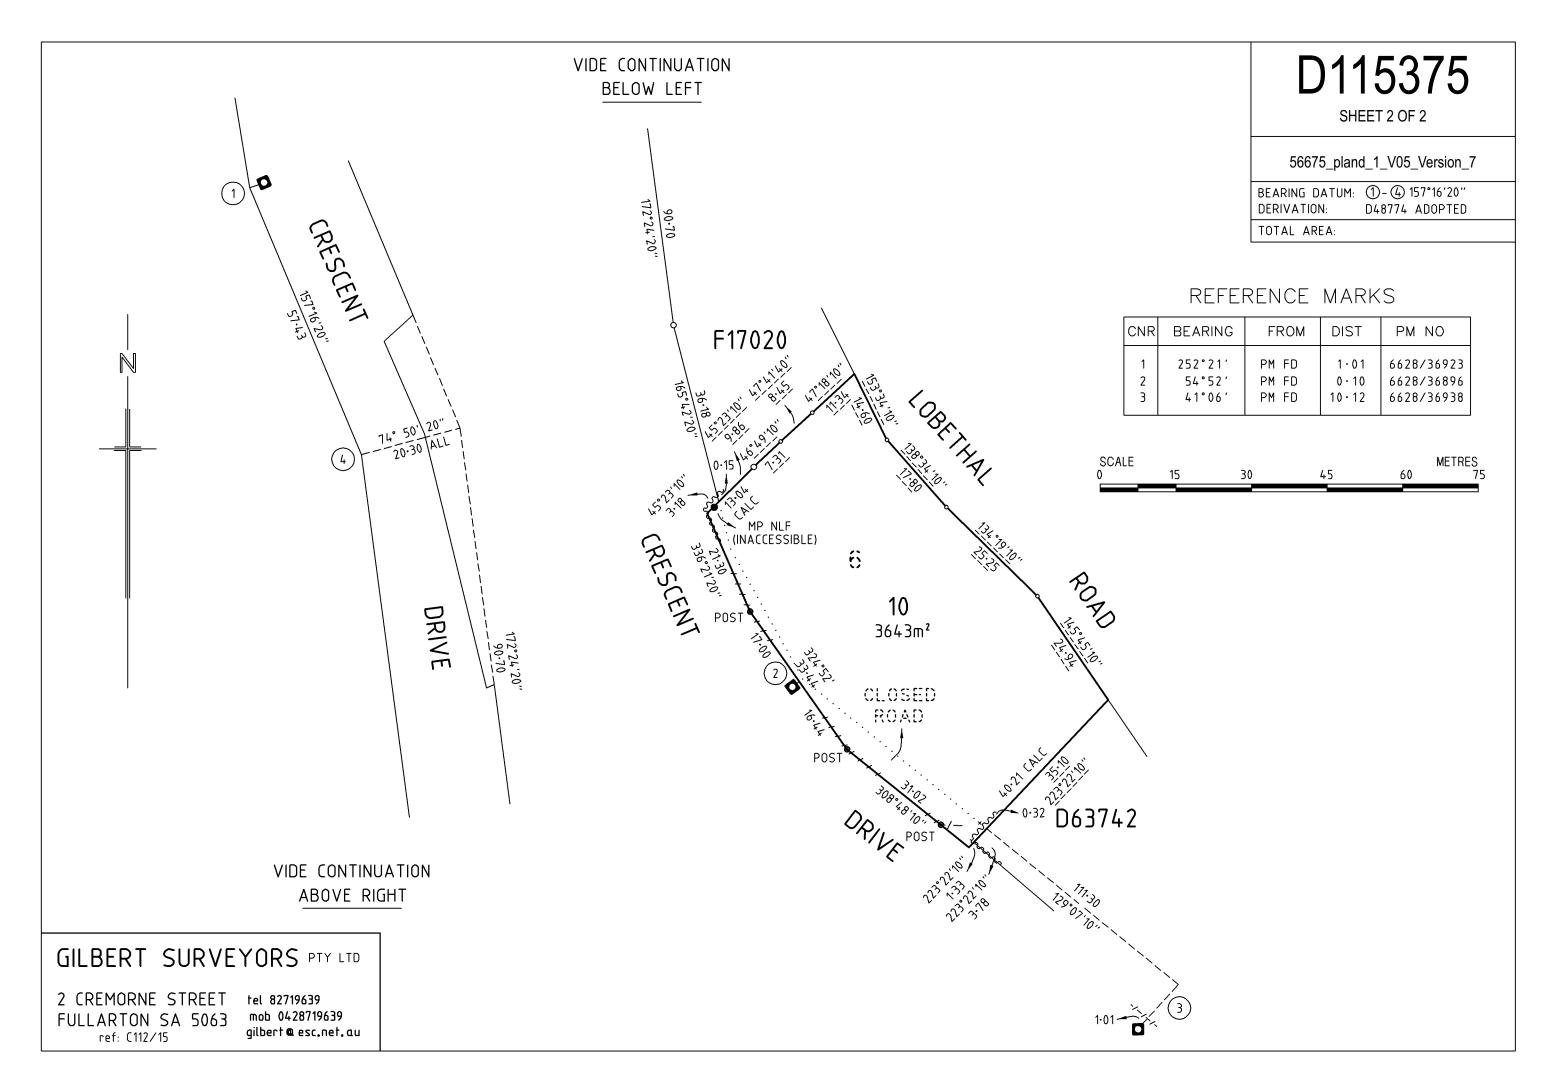



26th August 2024

Adelaide Hills Council 26 Onkaparinga Road Woodside SA 5244

Attn: Planning Department (Blake O'Neill)

RE: ID 21027228

Dear Blake.

We have lodged an application for a Minor Variation to the existing Planning approval ... ID 21027228 approval for B & B

We hereby submit amended Architectural plans showing:

- Proposed balcony facing Crescent Drive to the front of the dwelling (with one single door access only)
- Proposed balcony to the rear of the dwelling facing Lobethal Road (with one single door access & an additional window)
- Covered area internally in lieu of exposed beams

The balcony at the front is facing Crescent Drive and does not impede or overlook any neighbours

The balcony to the rear is facing Lobethal Road & does not overlook any neighbours, it looks directly into our own rear yard with spectacular views down the valley

Could you kindly assess this at your convenience

Please see attached:

Full set of combined PDF Architectural plans amended as at 12<sup>th</sup> June 2024

We await your response

Kind Regards



Jim Diamanti



P: (08) 82931526

**F:** (08) 82931521

W: diamantidd.com.au

A: PO Box 551, Marleston SA, 5033

E: admin@diamantidd.com.au



# WORKING DRAWINGS FOR CONSTRUCTION JUNE 24

# PROPOSED B&B TOURIST ACCOMMODATION AND EXISTING RESIDENCE MICHAEL VELONAKIS

# 31 CRESCENT DRIVE NORTON SUMMIT SA

SHEET	DRAWING LIST
01	GENERAL NOTES
02	PROPOSED SITE PLAN
03	FIRE FIGHTER SERVICES PLAN
04	FLOOR PLANS
05	SEWER FLOOR PLAN LAYOUT
06	PROPOSED B&B FLOOR PLAN (EXISTING HOUSE)
07	CONCRETE PLAN
08	JOIST LAYOUT
09	ELEVATIONS
10	ROOF PLAN
11	SECTION A-A
12	SECTION B-B
13	ELECTRICAL LAYOUT
14	WINDOW AND DOOR SCHEDULE
15	WET AREA DETAILS
16	BRACING DETAILS

ALL SITE DIMENSIONS ARE IN MILLIMETRES UNLESS SPECIFIED OTHERWISE.

REFER TO PLAN OF SUBDIVISION OR CERTIFICATE OF TITLE FOR VERIFICATION OF ALL BEARINGS, DISTANCES AND OTHER SITE INFORMATION.

FOR DETAILS OF ALL EASEMENTS REFER TO THE PLAN OF SUBDIVISION OR CERTIFICATE OF TITLE AND OTHER INFORMATION BY THE RESPONSIBLE AUTHORITY

INSTALLATION OF ALL SERVICES INCLUDING ALL STORMWATER, WASTE WATER AND SEWER DETAILS SHALL COMPLY WITH THE RESPECTIVE SUPPLY **AUTHORITY REQUIREMENTS.** 

BUILDER TO VERIFY ALL SET DETAILS ON SITE.

NEW WATER METERS ARE TO BE INSTALLED. ENSURE METERS ARE EQUIPPED WITH A BACKFLOW PREVENTION DEVICE & STOP TAP. CONNECT TO BUILDING IN ACCORDANCE WITH LOCAL AUTHORITIES REQUIREMENTS

CONNECT BUILDING WITH TELSTRA CABLES IN STRICT ACCORDANCE WITH TELSTRA'S REQUIREMENTS

CONNECT WATER SUPPLY TO THE SANITARY ITEMS WITHIN THE PROPOSED BUILDING & HWS WHERE REQUIRED IN ACCORDANCE WITH LOCAL AUTHORITIES REQUIREMENTS, SUPPLY HOT & COLD WATER TO NEW SANITARY ITEMS AS REQUIRED

PROVIDE UNDERGROUND POWER SUPPLY IN ACCORDANCE WITH POWER SUPPLIERS REQUIREMENTS

ALL DOWN PIPES TO BE CONNECTED TO WATER TANKS, ALL WATER TANKS TO HAVE OVER FLOW PIPE DISCHARGING INTO STORMWATER DRAINAGE. ALL CONNECTIONS TO BE IN ACCORDANCE WITH LOCAL AUTHORITIES REQUIREMENTS, REFER TO ENGINEERS PLANS FOR ALL DETAILS & SPECIFICATIONS.

THE CONTRACTOR AND SUBCONTRACTOR SHALL ENSURE THAT ALL STORMWATER DRAINS, SEWER PIPES AND THE LIKE ARE LOCATED AT A SUFFICIENT DISTANCE FROM ANY BUILDINGS FOOTINGS AND / OR SLAB EDGE BEAMS SO AS TO PREVENT GENERAL MOISTURE PENETRATION, DAMPNESS, WEAKENING AND UNDERMINING OF ANY BUILDING AND ITS FOOTING SYSTEM.

# STORMWATER NOTES

ALL 90mmø DOWN PIPE CONNECTIONS SHALL BE CLASS 6 UPVC SOLVENT WELDED JOINTED, LINE LAID TO A MINIMUM GRADE OF 1:100 & CONNECTED TO THE LEGAL POINT OF DISCHARGE TO THE RELEVANT AUTHORITIES APPROVAL. PROVIDE INSPECTION OPENINGS @ 9m MAX CTRS & @ EACH CHANGE OF DIRECTION. THE CONTRACTOR SHALL PROVIDE APPROVED DOWN PIPE TO STORM WATER ADAPTERS WHERE REQUIRED. THE TOP OF THESE ADAPTERS TO FINISH ABOVE EXIST GROUND / PAVING LEVEL.

THE COVER TO UNDERGROUND STORM WATER DRAINS SHALL BE NOT LESS THAN

- 100mm UNDER SOIL
- 50mm UNDER PAVED OR CONCRETE AREAS
- 100mm UNDER UNREINFORCED CONC. OR PAVED
- 75mm UNDER REINFORCED CONC. DRIVEWAYS

# **DRIVEWAYS GENERAL NOTES**

# **COMPACT FILL NOTES**

FILL USED ON SITE SHOULD BE PLACED AT OR NEAR OPTIMUM MOISTURE CONTENT AND COMPACTED IN ACCORDANCE WITH THE REQUIREMENTS OF SECTION 6 OF AS 2879-2011, AS SUMMARISED BELOW:

(A) NON-SAND FILL UP TO 300mm IN DEPTH OR SAND FILL UP TO 600mm DEEP, COMPACTED IN NOT MORE THAN 150mm LAYERS BY REPEATED ROLLING BY AN EXCAVATOR, IS CLASSED AS ROLLED FILL AND MAY BE USED FOR SUPPORT OF SLAB PANELS AND INTERNAL BEAMS. NOTE THAT EDGE BEAMS MUST BE SUPPORTED ON ORIGINAL GROUND OR ON CONTROLLED FILL AS DEFINED IN (B) BELOW:

(B) NON-SAND FILL UP TO 400mm IN DEPTH OR SAND FILL UP TO 800mm DEEP, COMPACTED BY MECHANICAL ROLLER OR VIBRATING PLATE RESPECTIVELY, IN LAYERS NOT MORE THAN 150mm THICK AND AT CLOSE TO OPTIMUM MOISTURE CONTENT, IS DEEMED TO COMPLY AS CONTROLLED FILL. IT IS DEEMED TO COMPLY AS SUITABLE FOR FOUNDING THE SLAB, EDGE AND INTERNAL BEAMS.

THE REQUIREMENTS OF AS 2879-2011 FOR CONSTRUCTION OF THE FOOTINGS AND LANDSCAPING OF THE SITE SHOULD BE FOLLOWED, WITH PARTICULAR ATTENTION PAID TO SURFACE DRAINAGE AND AVOIDANCE OF PONDING NEXT TO FOOTINGS. TREES SHOULD BE PLANTED NO CLOSER TO THE FOOTINGS THAN 1.0x MATURE HEIGHT.

SHOULD SOIL CONDITIONS DIFFERING THAN DESCRIBED BE FOUND DURING EXCAVATION WORKS. ESPECIALLY THE PRESENCE OF UNREPORTED FILL OR POORLY COMPACTED MATERIAL. PLEASE CONTACT THIS OFFICE

# **TERMITE PROTECTION NOTES**

WHERE THE BUILDING (EXCLUDES A DETACHED CLASS 10) IS LOCATED IN A TERMITE PRONE AREA, THE AREA TO UNDERSIDE OF BUILDING AND PERIMETER IS TO BE TREATED AGAINST TERMITE

A TERMITE BARRIER OR COMBINATION OF BARRIERS MUST BE INSTALLED IN ACCORDANCE WITH AS 3660.1

THE AREA BENEATH THE SUSPENDED FLOOR MUST BE VENTILATED IN ACCORDANCE WITH THE BCA & INSPECTED IN ACCORDANCE WITH AS 3660.1. ALL TIMBER COMPLETELY OR PARTICALLY PROTECTED FROM WATHER TO BE H2 TREATED ALL TIMBER OUTSIDE AND ABOVE GROUND SHALL BE H3 TREATED

ALL TIMBER THAT IS NON-STRUCTURAL THAT IS IN CONTACT WITH GROUND OR WATER SHALL BE H4

# RAINWATER TANK NOTES

SUITABLE WATER TANK/S SHALL BE INSTALLED COMPLETE WITH PRESSURE PUMP, SUPPLY PIPE AND GATE VALVE. RAINWATER SHALL BE PROVIDED TO THE ENTIRE RESIDENCE INCLUDING HWS. TANK OVERFLOW MUST BE DISCHARGED INTO THE EXIST PADDOCK IN ACCORDANCE WITH LOCAL AUTHORITIES REQUIREMENTS. INSTALLATION TO COMPLY WITH RELEVANT REGULATIONS AND MANUFACTURER'S RECOMMENDATIONS

# KITCHEN NOTES

ALL KITCHEN DETAILS BY OWNER -VERIFY ALL LAYOUTS, APPLIANCE SIZES & LOCATION ON SITE PRIOR TO CONTRUCTION

GAS COOKTOPS ARE TO BE 200mm OR GREATED FROM A STAINLESS STEEL OR GLASS SPLASHBACK WALL. IF CLEARANCE IS LESS THAN 200mm, THE FOLLOWING MUST APPLY:

STAINLESS STEEL-

(A) THE WALL MUST NOT CONTAIN COMBUSTIBLE MATERS OR

(B) THE SURFACE OF THE WALL IS TO BE PROTECTED AS PÉR AS 5601/AG601, CLAUSE 5,12,1 **TOUGHENED GLASS-**

(A) A LETTER IS TO BE SUPPLIED BY GLASS SUPPLIER OR GLASS MANUFACTURER INDICATED THAT THE GLASS IS FIT FOR PURPOSE AT THE CLEARANCE STATED AND: (B) IF THE GLASS IS FIXED TO A COMPUSTIBLE SURFACE. THAT SURFACE IS TO BE PROTECTED AS PER AS 5601/AG 601 CLAUSE 5.12.1

THIS MAY ALSO BE MEET IF DOCUMENTATION IS PROVIDED TO THE EFFECT THAT THE FIXING METHODS WITH ENSURE THE TEMPERATURE OF THE COMPUSTIBLE SURFACE WILL NOT EXCEED 65°C

# **HEATING APPLIANCE**

TO BE INSTALLED IN ACCORDANCE WITH MANUFACTURER'S SPECIFICATIONS TO COMPLY WITH BCA VOI 1

# **ENERGY EFFICIENCY**

CONSTRUCTION TO COMPLY WITH BCA VOL. 1 REFER TO ENERGY RATER'S REPORT.

# **BATHROOM & ENSUITE**

ALL INSITU SHOWER ENCLOSURE FLOOR TO BE GRADED TOWARDS OUTLET WITH GRADE NOT LESS THAN 1:60 FALL REFER TO BCA

FLOOR TO BE TILED & TO BE NON-SLIP ALL AREAS TO BE CONSTRUCTED IN ACCORDANCE WITH **BCA** 

GLAZED SCREEN & DOORS AS SELECTED TO COMPLY WITH BCA

ALL FIXTURES, FITTINGS & FINISHES AS SELECTED VANITY WITH SELECTED FINISH OPENING DOORS WITH **CENTRAL SHELF** 

TILE ABOVE VANITY TO MIN. 150mm INSTALL FRAMED MIRROR AS SELECTED TO WALL ABOVE VANITY

BATH AS SELECTED SET IN TILED HOB UNLESS OTHERWISE NOTED ALL WORK IN ACCORDANCE WITH BCA

### LAUNDRY

STAINLESS STEEL TROUGH INSET IN BENCH AS **SELECTED** 

SELECTED FINISH TO BENCH & CUPBOARDS TILE BEHIND BENCH & WASHER TO MIN. HEIGHT OF 500mm

WET AREA TO COMPLY WITH BCA PRIVIDE NOGGING FOR WALL MOUNTED DRYER OVER WASHER

PROVIDE FLOOR OUTLET.

# FOR CONSTRUCTION JUNE 24 **GENERAL NOTES**

VERIFY ALL FINISHED FLOOR LEVELS BEFORE THE COMMENCEMENT OF ANY BUILDING WORK.

ALL SANITARY PLUMBING WORK TO BE CARRIED OUT BY FULLY QUALIFIED AND LICENCED TRADES PERSONS, AS PER AS

ALL ELECTRICAL WORK CARRIED OUT TO BE IN ACCORDANCE WITH AS 3000,

THIS DRAWING TO BE READ IN CONJUNCTION WITH ALL OTHER DRAWINGS. DOCUMENTS, SCHEDULES AND SPECIFICATIONS.

TERMITE PROTECTION SHALL COMPLY WITH AS3660, 1-2000, PROVIDE CERTIFICATE IN ACCORDANCE WITH AS3660, 1-2000 STATING METHOD OF APPLICATION AND CERTIFICATE OF COMPLETION

ROOF CONTRACTOR SHALL PROVIDE ALL NECESSARY FLASHINGS, CAPPINGS AND OTHER ITEMS REQUIRED TO MAKE THE ROOF WATERTIGHT AND COMPLETE.

BUILDER TO CHECK AND CONFIRM ALL SITE AND SET OUT DIMENSIONS PRIOR TO COMMENCEMENT OF CONSTRUCTION.

REFER TO ENGINEERS DOCUMENTATION FOR DETAILS ON FOOTING, STRUCTURE, SITEWORKS AND STORMWATER DETAILS

ALL STEEL WORK TO COMPLY WITH BCA

OWNERS RESPONSIBILITY TO WASH DOWN ALL PRE-PAINTED AND PAINTED SURFACES ON A REGULAR BASIS FOR LONGEVITY OF PRODUCT.

DRAUGHT PROTECTION DEVICES TO BE INSTALLED TO ALL EXTERNAL DOORWAYS

HOT WATER SUPPLY SYSTEM DESIGNED AND INSTALLED IN ACCORDANCE WITH SECTION 6A OF AS/NZS 3500.4.2 OR CLAUSE 3.38 OF AS/NZS 3500.5

NOTE: ALL EXISTING DIMENSIONS TO BE CONFIRMED ON SITE PRIOR TO COMMENCEMENT OF CONSTRUCTION

NOTE: FINISHED FLOOR LEVEL TO BE A MINIMUM OF 300MM ABOVE TOP OF ROADSIDE KERB LEVEL

CONSTRUCTION TO COMPLY WITH BCA REFER TO ENERGY RATER'S REPORT.

SMOKE DETECTORS TO COMPLY WITH AS1670

CLIENT: MICHAEL VELONAKIS PROPOSED PROPOSED B&B TOURIST ACCOMMODATION AND EXISTING

RESIDENCE SITE ADDRESS 31 CRESCENT DRIVE NORTON SUMMIT

DATE: JUNE 2024 DRAWN: GR SHEET: 1 OF 16

JOB No.




MANAGEMENT PO Box 551, Marleston SA, 5033

PHONE: 0419851867 WEBSITE: www.diamantidesign.com.au EMAIL: jim@diamantidd.com.au

THESE DESIGNS ARE COPYRIGHT. LEGAL ACTION WILL BE TAKEN AGAINST ANY INFRINGEMENT IN PART OR WHOLE UNLESS WRITTEN AUTHORITY IS GIVEN BY THE DESIGNER.

FIGURED DIMENSIONS SHALL TAKE PREFERENCE OVER SCALED DRAWINGS. VERIFY DIMENSIONS AND LEVELS BEFORE COMMENCING ANY BUILDING WORK. ANY DISCREPANCY TO BE REPORTED TO THE DESIGNERS IMMEDIATELY.

# **FOR CONSTRUCTION JUNE 24**

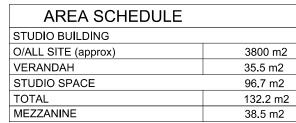

REFER TO SHEET 4 FOR ENLARGED DETAILS

EXISTING RETAINING WALL TO BE RELOCATED

CLIENT:
MICHAEL VELONAKIS
PROPOSED:
PROPOSED B&B TOURIST
ACCOMMODATION AND EXISTING
RESIDENCE
SITE ADDRESS:
31 CRESCENT DRIVE
NORTON SUMMIT
DATE: JUNE 2024
DRAWN: GR
SHEET: 2 OF 16




JOB No.

PO Box 551, Marleston SA, 5033

PHONE: 0419851867 WEBSITE: www.diamantidesign.com.au EMAIL: jim@diamantidd.com.au

THESE DESIGNS ARE COPYRIGHT. LEGAL ACTION WILL BE TAKEN AGAINST ANY INFRINGEMENT IN PART OR WHOLE UNLESS WRITTEN AUTHORITY IS GIVEN BY THE DESIGNER.


FIGURED DIMENSIONS SHALL TAKE PREFERENCE OVER SCALED DRAWINGS. VERIFY DIMENSIONS AND LEVELS BEFORE COMMENCING ANY BUILDING WORK. ANY DISCREPANCY TO BE REPORTED TO THE DESIGNERS IMMEDIATELY.

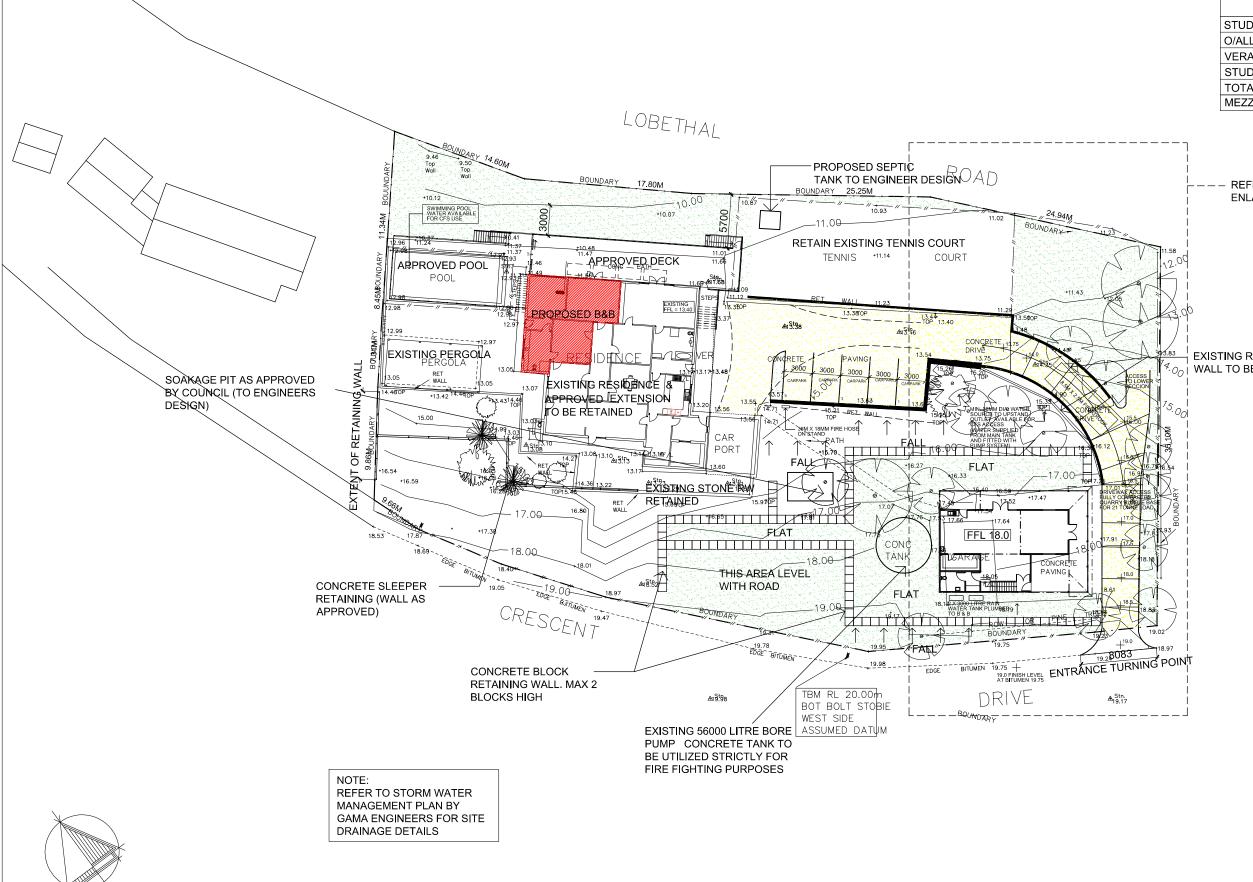

PROPOSED SITE PLAN

SCALE 1:400 @ A3

# FOR CONSTRUCTION JUNE 24

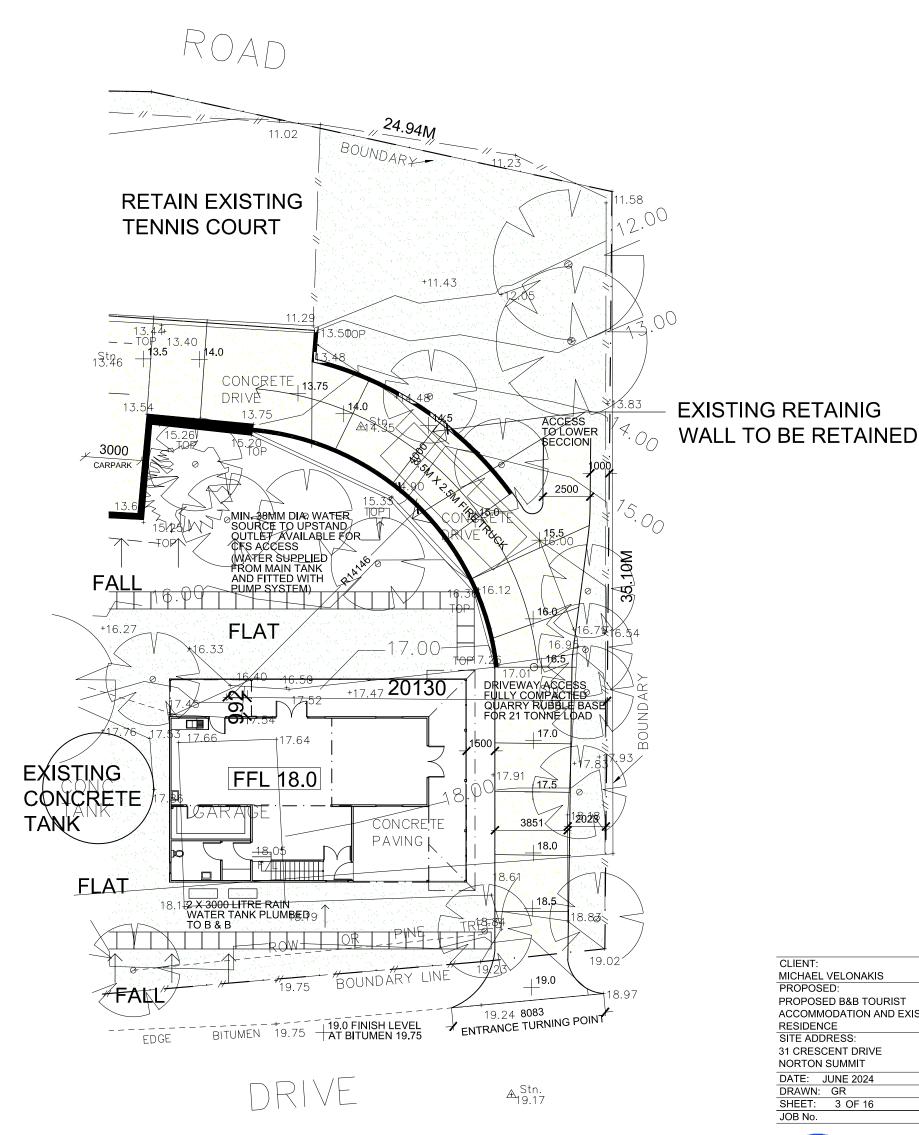

NOTE: GRADIENT OF DRIVEWAY 5.85M OVER 35M PROVIDE 12° GRADIENT (19.0 AT ROAD LEVEL 13.75 ON BOTTOM OF DRIVEWAY)

CLIENT: MICHAEL VELONAKIS PROPOSED:

PROPOSED B&B TOURIST ACCOMMODATION AND EXISTING RESIDENCE

SITE ADDRESS: 31 CRESCENT DRIVE NORTON SUMMIT

DATE: JUNE 2024 DRAWN: GR 3 OF 16

SHEET: JOB No.






PHONE: 0419851867 WEBSITE: www.diamantidesign.com.au EMAIL: jim@diamantidd.com.au

THESE DESIGNS ARE COPYRIGHT, LEGAL ACTION WILL BE TAKEN AGAINST ANY INFRINGEMENT IN PART OR WHOLE UNLESS WRITTEN AUTHORITY IS GIVEN BY THE DESIGNER.


FIGURED DIMENSIONS SHALL TAKE PREFERENCE OVER SCALED DRAWINGS. VERIFY DIMENSIONS
AND LEVELS BEFORE COMMENCING ANY DING WORK, ANY DISCREPANCY TO BE ORTED TO THE DESIGNERS IMMEDIATELY.


FIRE FIGHTING SERVICES PLAN

SCALE 1:100 @ A3

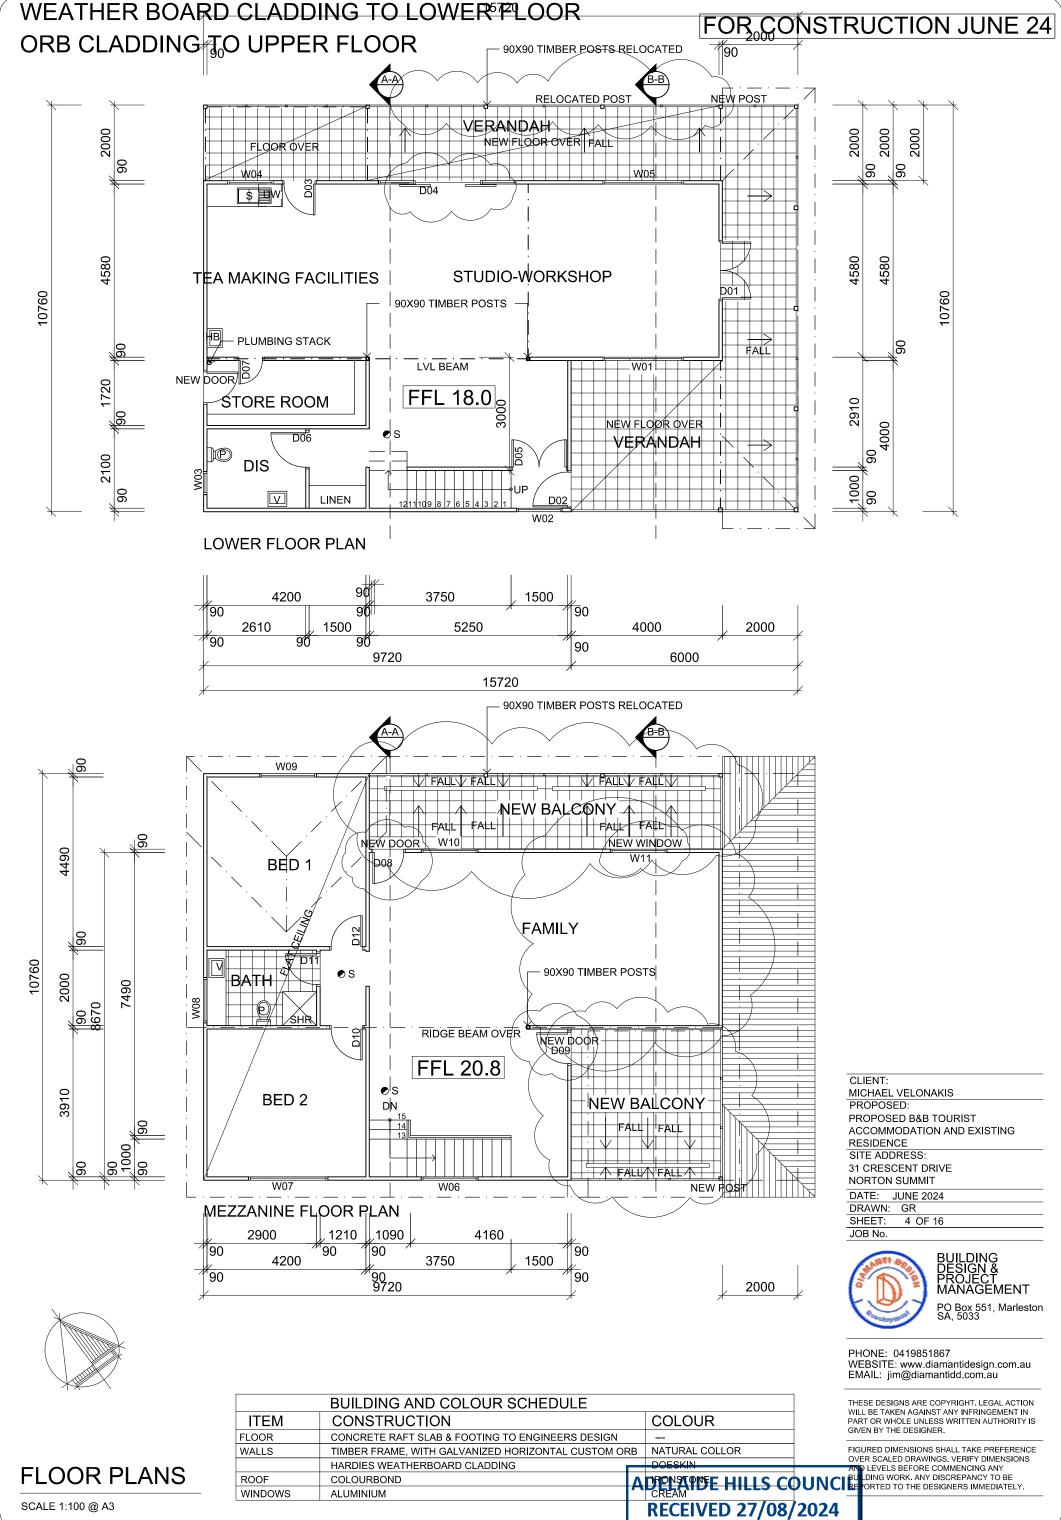

SCALE 1:100 @ A3

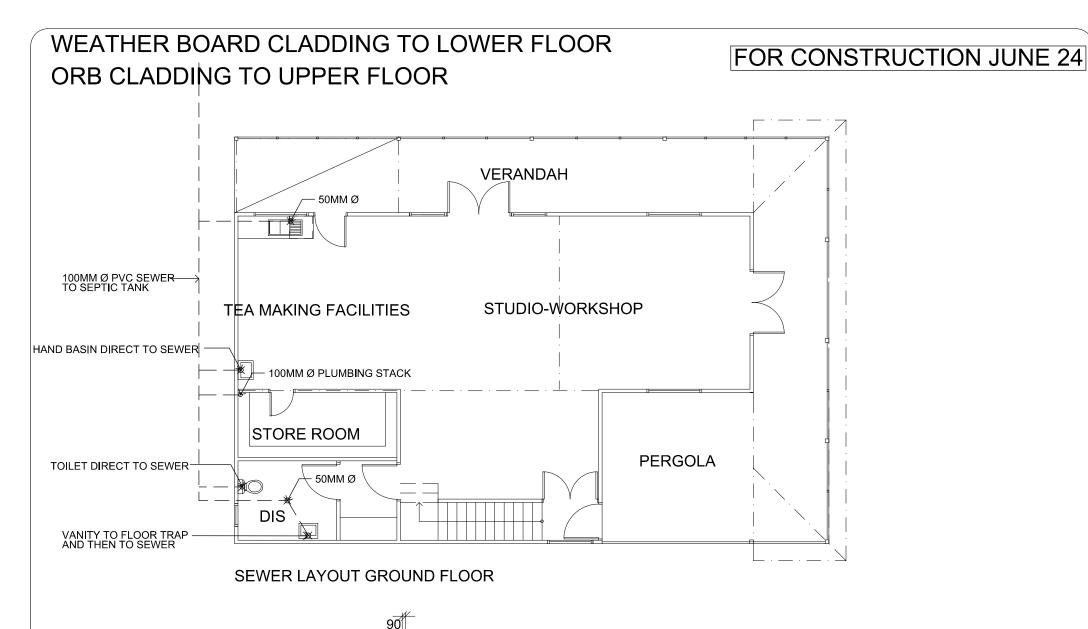

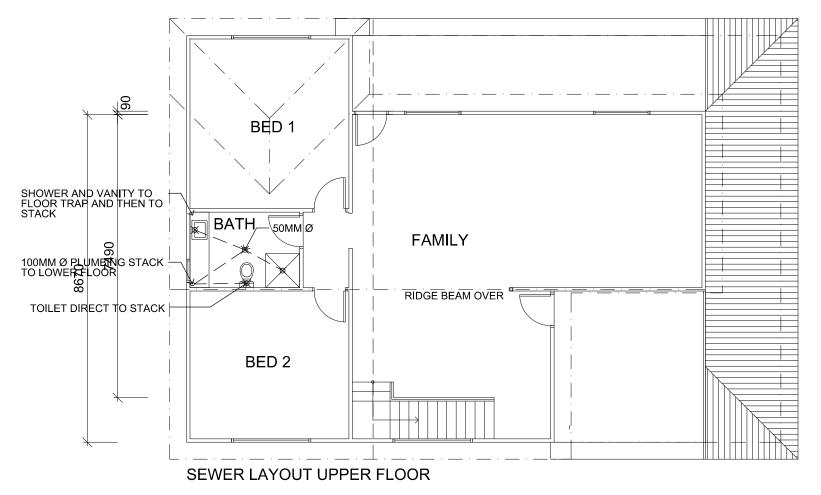

CLIENT: MICHAEL VELONAKIS PROPOSED: PROPOSED B&B TOURIST ACCOMMODATION AND EXISTING RESIDENCE SITE ADDRESS: 31 CRESCENT DRIVE NORTON SUMMIT DATE: JUNE 2024 DRAWN: GR SHEET: 5 OF 16 JOB No.



BUILDING DESIGN & PROJECT MANAGEMENT PO Box 551, Marleston SA, 5033

PHONE: 0419851867 WEBSITE: www.diamantidesign.com.au EMAIL: jim@diamantidd.com.au


THESE DESIGNS ARE COPYRIGHT. LEGAL ACTION WILL BE TAKEN AGAINST ANY INFRINGEMENT IN PART OR WHOLE UNLESS WRITTEN AUTHORITY IS GIVEN BY THE DESIGNER.

FIGURED DIMENSIONS SHALL TAKE PREFERENCE OVER SCALED DRAWINGS. VERIFY DIMENSIONS
AND LEVELS BEFORE COMMENCING ANY
BULLDING WORK. ANY DISCREPANCY TO BE


**SEWER LAYOUT** 

SCALE 1:100 @ A3

ADELAIDE HILLS COUNCI₽ ORTED TO THE DESIGNERS IMMEDIATELY. **RECEIVED 27/08/2024** 

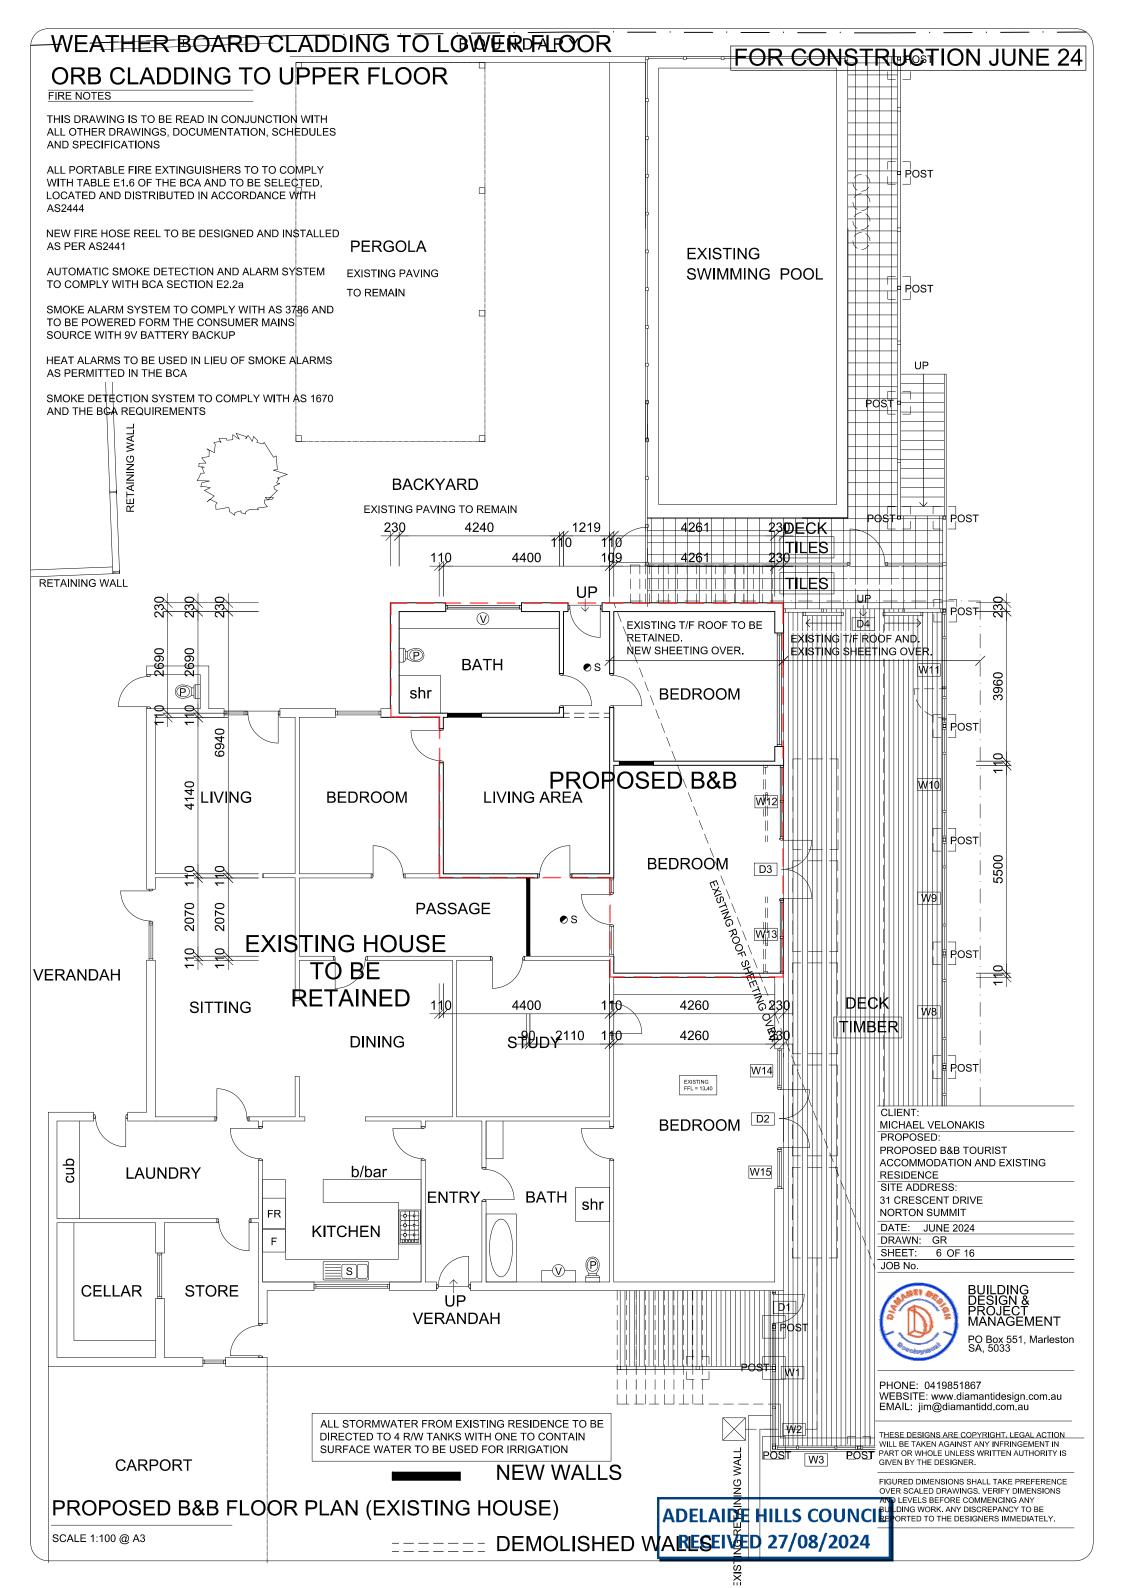

# FOR CONSTRUCTION JUNE 24

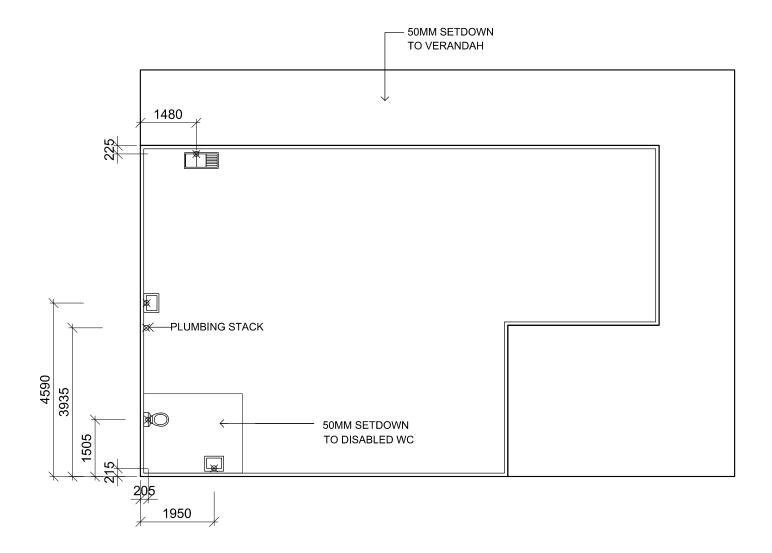

CLIENT:
MICHAEL VELONAKIS
PROPOSED:
PROPOSED B&B TOURIST
ACCOMMODATION AND EXISTING
RESIDENCE
SITE ADDRESS:
31 CRESCENT DRIVE
NORTON SUMMIT
DATE: JUNE 2024
DRAWN: GR
SHEET: 070F 16
JOB No.



**RECEIVED 27/08/2024** 

BUILDING DESIGN & PROJECT MANAGEMENT PO Box 551, Marleston SA, 5033

PHONE: 0419851867 WEBSITE: www.diamantidesign.com.au EMAIL: jim@diamantidd.com.au

THESE DESIGNS ARE COPYRIGHT. LEGAL ACTION WILL BE TAKEN AGAINST ANY INFRINGEMENT IN PART OR WHOLE UNLESS WRITTEN AUTHORITY IS GIVEN BY THE DESIGNER.


FIGURED DIMENSIONS SHALL TAKE PREFERENCE OVER SCALED DRAWINGS, VERIFY DIMENSIONS AND LEVELS BEFORE COMMENCING ANY ADELAIDE HILLS COUNCILE ORTHOGONE OR THE DESIGNERS IMMEDIATELY.

CONCRETE FOOTINGS TO

ENGINEERS DESIGN AND DETAIL



# FOR CONSTRUCTION JUNE 24

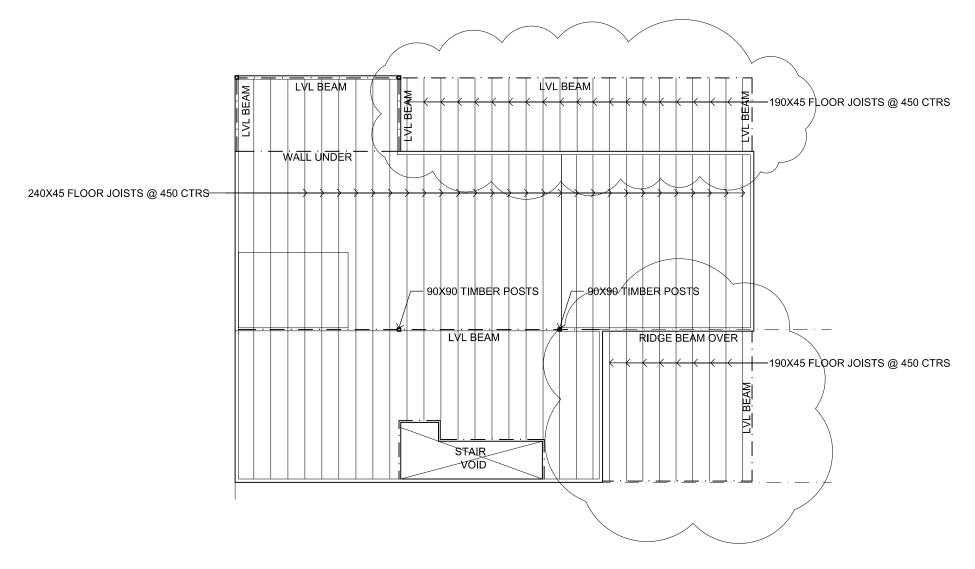

CLIENT:
MICHAEL VELONAKIS
PROPOSED:
PROPOSED B&B TOURIST
ACCOMMODATION AND EXISTING
RESIDENCE
SITE ADDRESS:
31 CRESCENT DRIVE
NORTON SUMMIT
DATE: JUNE 2024
DRAWN: GR
SHEET: 080F 16




JOB No.


BUILDING DESIGN & PROJECT MANAGEMENT PO Box 551, Marleston SA, 5033

PHONE: 0419851867 WEBSITE: www.diamantidesign.com.au EMAIL: jim@diamantidd.com.au


THESE DESIGNS ARE COPYRIGHT. LEGAL ACTION WILL BE TAKEN AGAINST ANY INFRINGEMENT IN PART OR WHOLE UNLESS WRITTEN AUTHORITY IS GIVEN BY THE DESIGNER.

FIGURED DIMENSIONS SHALL TAKE PREFERENCE OVER SCALED DRAWINGS, VERIFY DIMENSIONS AND LEVELS BEFORE COMMENCING ANY BUILDING WORK, ANY DISCREPANCY TO BE REPORTED TO THE DESIGNERS IMMEDIATELY.

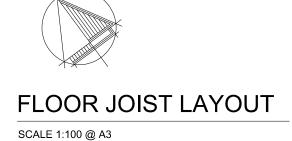


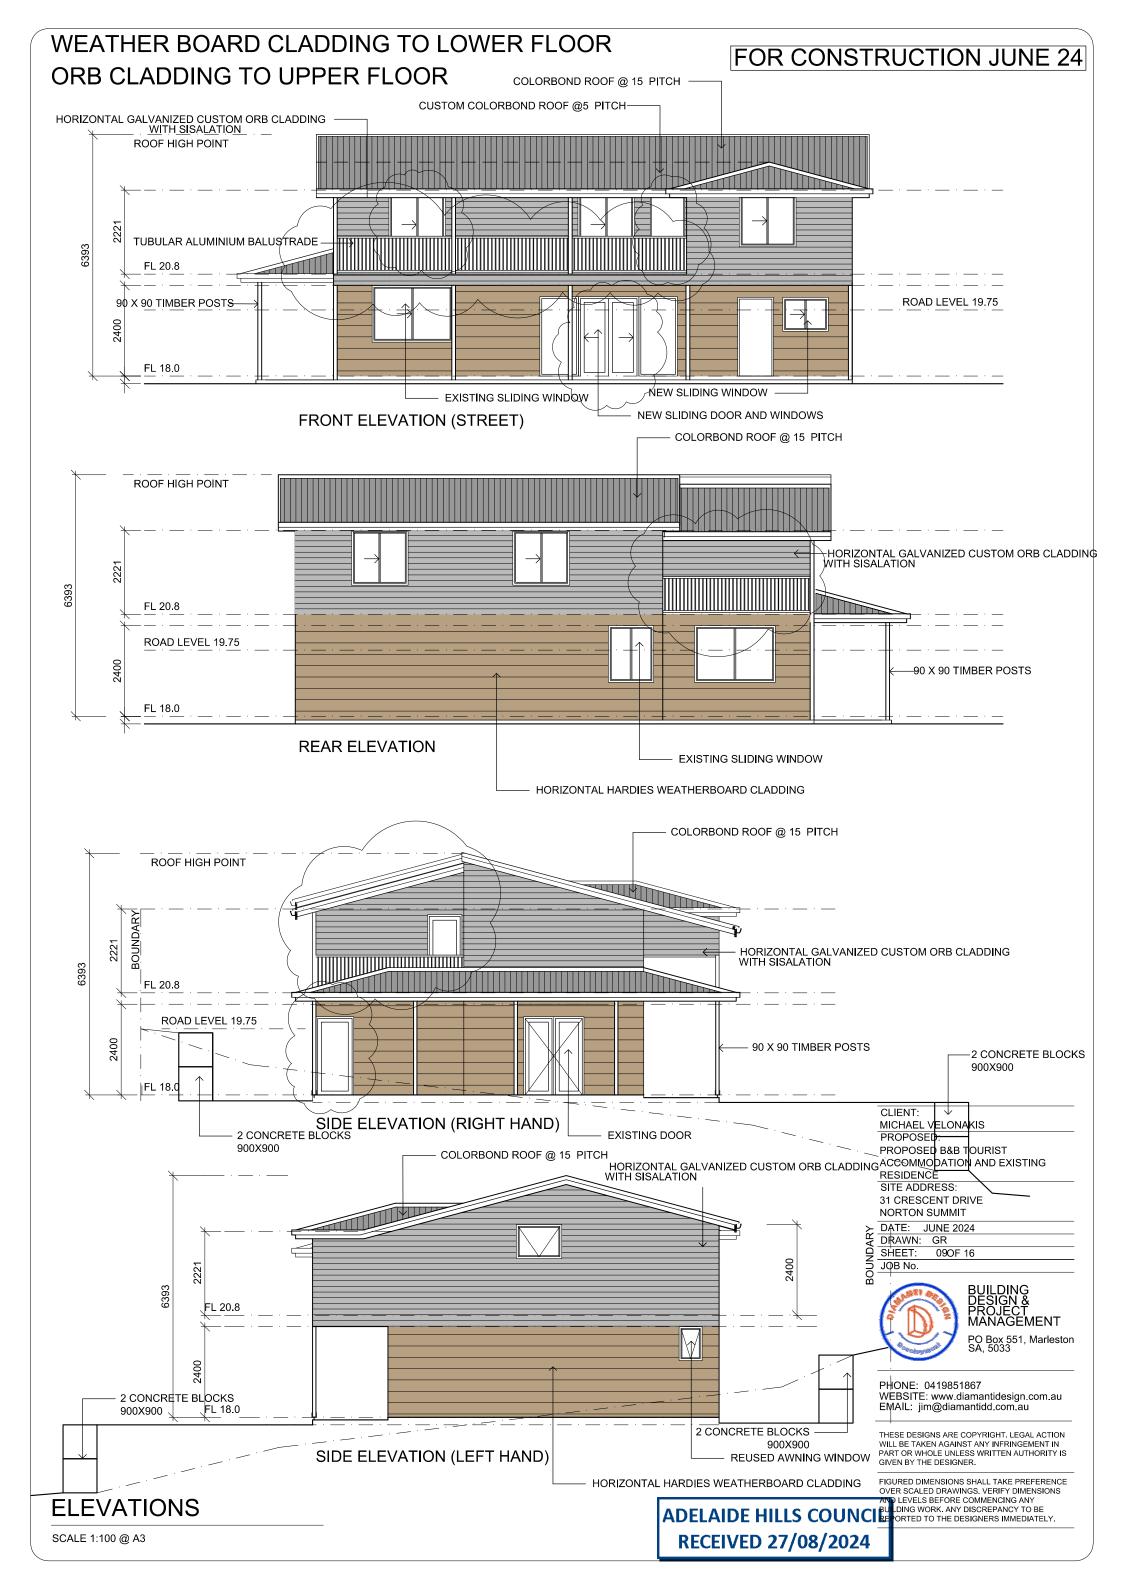

# FOR CONSTRUCTION JUNE 24

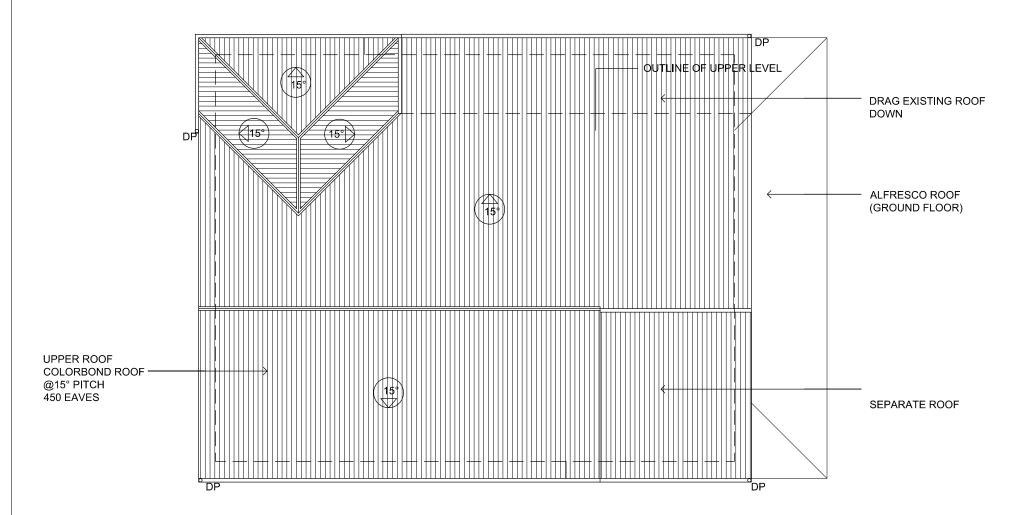

**UPPER LEVEL** 

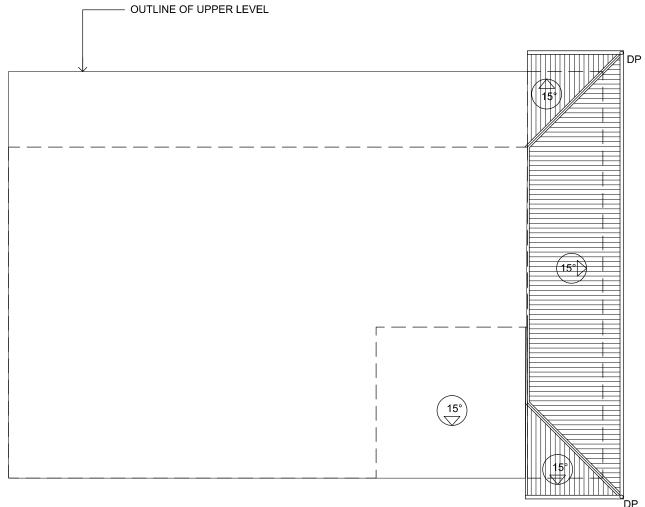

ALFRESCO ROOF LOWER LEVEL CLIENT:
MICHAEL VELONAKIS
PROPOSED:
PROPOSED B&B TOURIST
ACCOMMODATION AND EXISTING
RESIDENCE
SITE ADDRESS:
31 CRESCENT DRIVE
NORTON SUMMIT
DATE: JUNE 2024

DRAWN: GR
SHEET: 10 OF 16
JOB No.





BUILDING DESIGN & PROJECT MANAGEMENT PO Box 551, Marleston SA, 5033

PHONE: 0419851867 WEBSITE: www.diamantidesign.com.au EMAIL: jim@diamantidd.com.au


THESE DESIGNS ARE COPYRIGHT. LEGAL ACTION WILL BE TAKEN AGAINST ANY INFRINGEMENT IN PART OR WHOLE UNLESS WRITTEN AUTHORITY IS GIVEN BY THE DESIGNER.

FIGURED DIMENSIONS SHALL TAKE PREFERENCE OVER SCALED DRAWINGS, VERIFY DIMENSIONS AND LEVELS BEFORE COMMENCING ANY BULLDING WORK, ANY DISCREPANCY TO BE REPORTED TO THE DESIGNERS IMMEDIATELY.

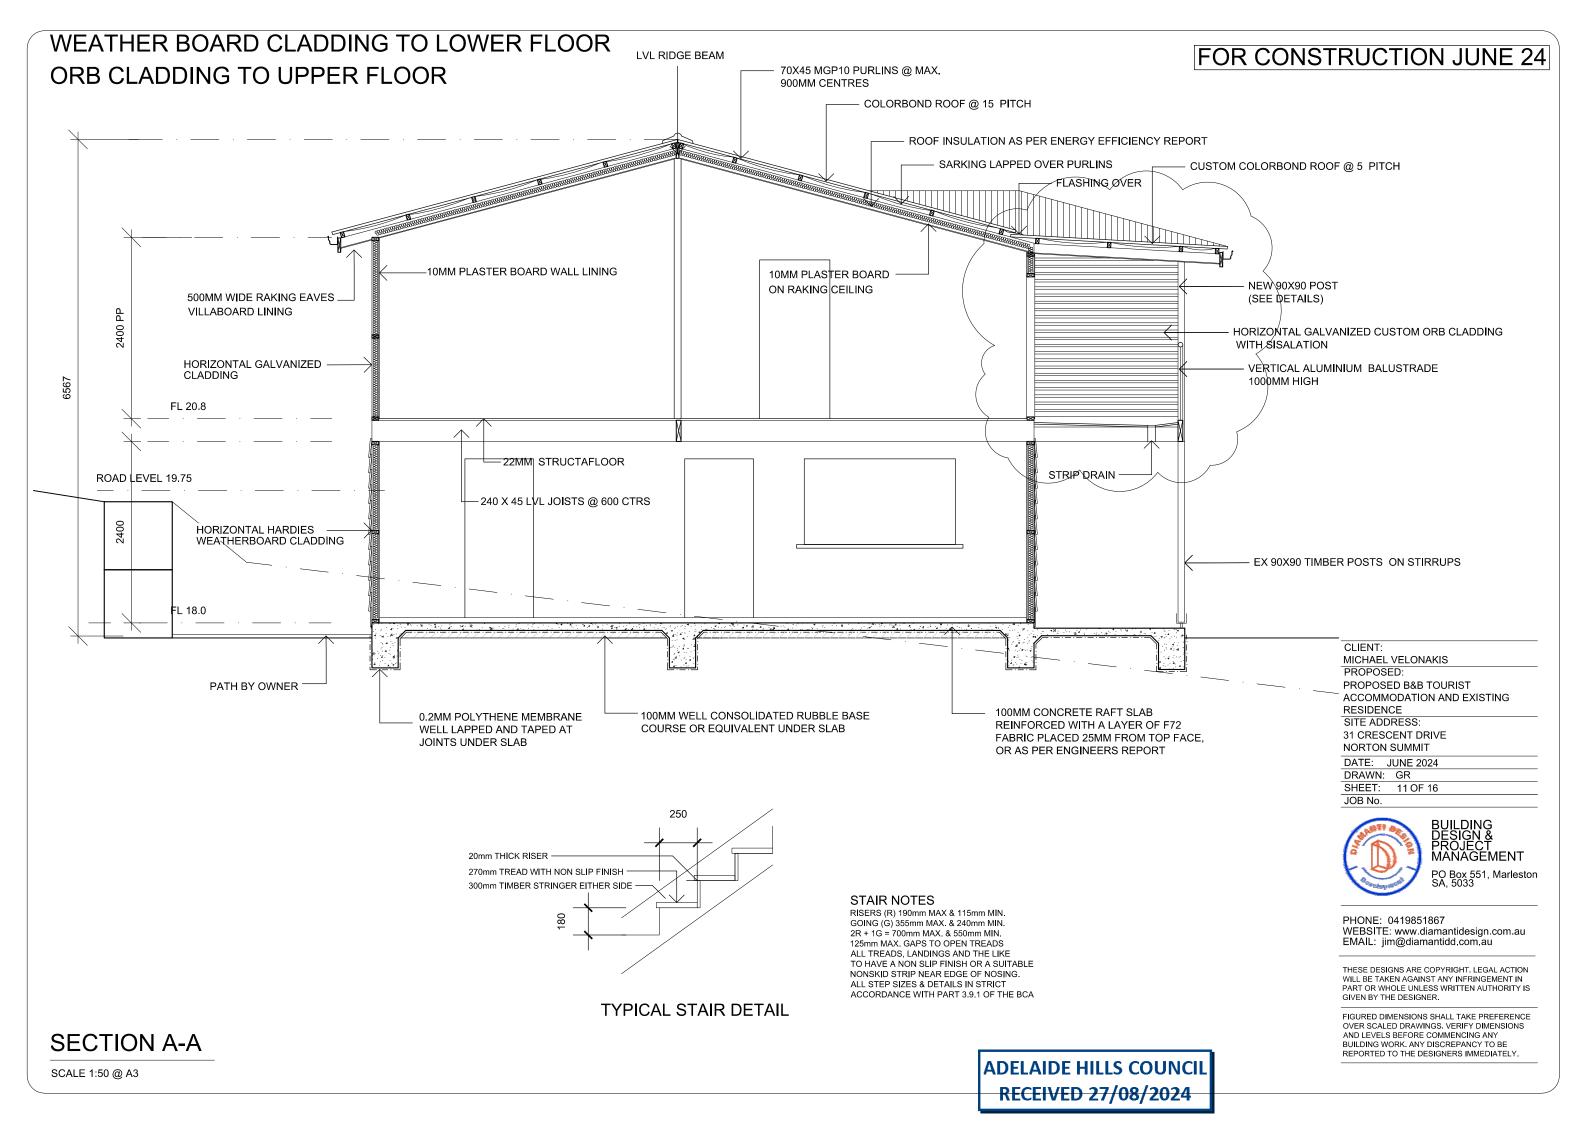


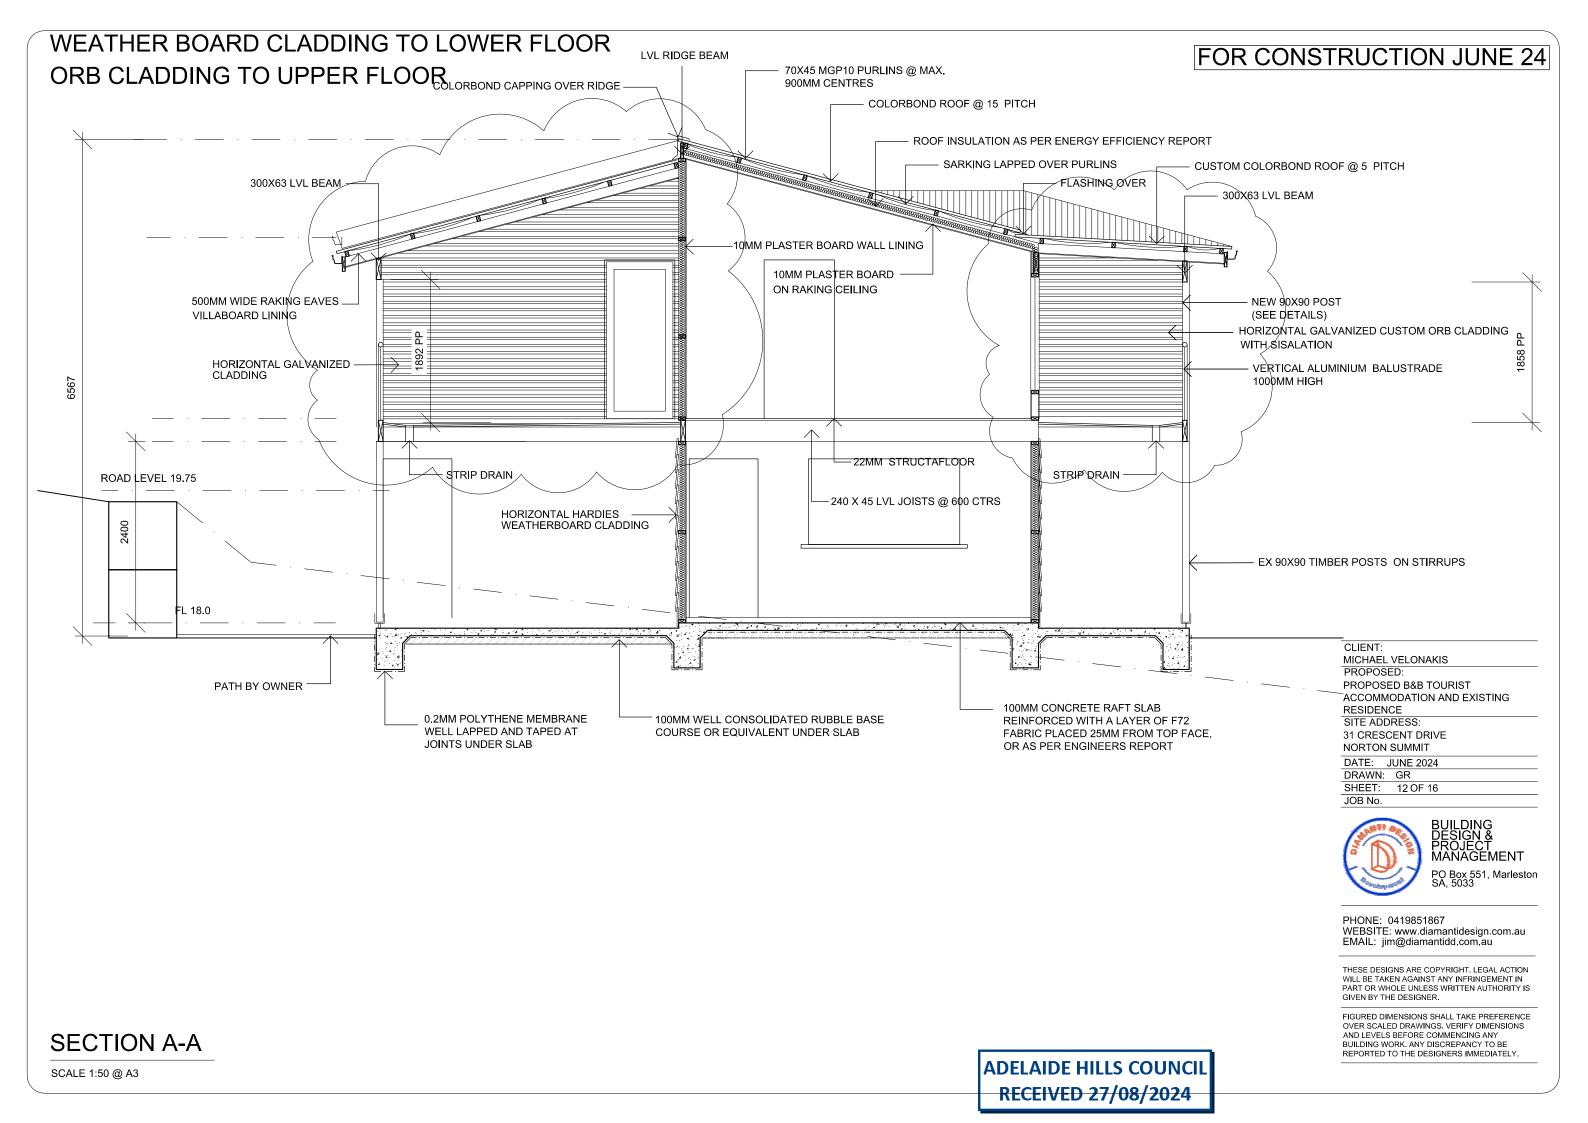


# FOR CONSTRUCTION JUNE 24

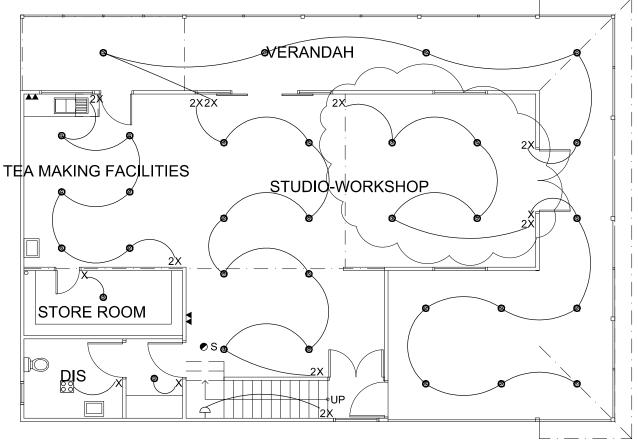

# LOWER FLOOR PLAN

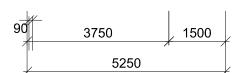

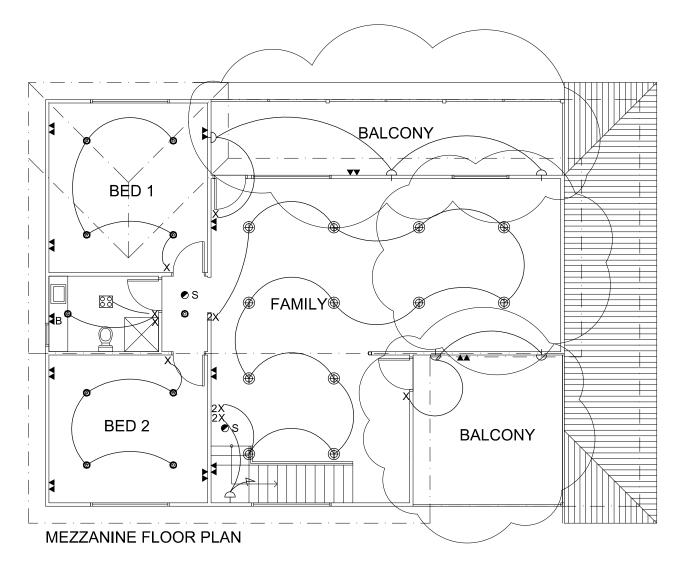

ICON	ITEM	
AA	300 AFL* DOUBLE POWER OUTLET	
_	300 AFL* SINGLE POWER OUTLET	
_ ▲WP		
▲ B	1200 AFL* BENCH HEIGHT GPO	
▲ UB	600 AFL* UNDER BENCH GPO	
ΔTV	300 AFL* TV POINT	
ΔP	300 AFL* PHONE POINT	
△ DATA	300 AFL* DATA POINT	
0	DOWN LIGHT LOW VOLTAGE	
<b>+</b>	LIGHT BATTEN HOLDER	
( <del>-</del>	WALL LIGHT	
<b>®</b>	PENDANT LIGHT	
$\bigcirc$	SENSOR LIGHT	
X 2	TWO WAY CIRCUIT	
X	LIGHT SWITCH	
88	3 IN 1 BATHROOM LIGHTS	
В МВ	METER BOX	
	SMOKE DETECTOR	
	HARD WIRED WITH	
94	BATTERY BACKUP	
<u>—</u>	FLUORESCENT LIGHT	
	CEILING FANLIGHT	
3 🗶 📗	CEILING FAN	
<b>₩</b> S	HOT WATER SYSTEM	
<b>+</b>	EXHAUST FAN	
0	SECURITY CAMERA	
▲ F	1800 AFL* FRIDGE GPO	
▲ FZ	1800 AFL* FREEZER GPO	
□ INT	INTERCOM	
▲WM	600 AFL * WASHING MACHINE GPO	
▲DR	600 AFL * DRYER GPO	
▲C	GPO ON CEILING	
▲DW	600 AFL * DISH WASHER GPO	
	* UNLESS OTHERWISE NOTED	

CLIENT:
MICHAEL VELONAKIS
PROPOSED:
PROPOSED B&B TOURIST
ACCOMMODATION AND EXISTING
RESIDENCE
SITE ADDRESS:
31 CRESCENT DRIVE
NORTON SUMMIT
DATE: JUNE 2024
DRAWN: GR
SHEET: 130F 16
JOB No.



BUILDING DESIGN & PROJECT MANAGEMENT PO Box 551, Marleston SA, 5033

PHONE: 0419851867 WEBSITE: www.diamantidesign.com.au EMAIL: jim@diamantidd.com.au

THESE DESIGNS ARE COPYRIGHT. LEGAL ACTION WILL BE TAKEN AGAINST ANY INFRINGEMENT IN PART OR WHOLE UNLESS WRITTEN AUTHORITY IS GIVEN BY THE DESIGNER.

FIGURED DIMENSIONS SHALL TAKE PREFERENCE OVER SCALED DRAWINGS, VERIFY DIMENSIONS AND LEVELS BEFORE COMMENCING ANY BULDING WORK, ANY DISCREPANCY TO BE REPORTED TO THE DESIGNERS IMMEDIATELY.

# FOR CONSTRUCTION JUNE 24

# WINDOW AND DOOR NOTES

CONTRACTOR MUST SEAL & FLASH ALL GAPS & CRACKS AROUND WINDOW & DOOR FRAMES PRIOR TO FIXING PLASTERBOARD

INTERNAL DOORS TO BE TIMBER FRAMED UNLESS STATED OTHERWISE.

WINDOWS TO BE ALUMINIUM FRAMED, WITH SUITABLE MATCHING FLY SCREENS TO ALL OPENABLE SASHES UNLESS STATED OTHERWISE.

ALL OPENABLE WINDOWS SHALL HAVE KEYED ALIKE LOCKS

VERIFY ALL SIZES PRIOR TO ORDERING & CONSTRUCTING

DOORS & WINDOWS TO BE HANDLED, FINISHED & INSTALLED IN ACCORDANCE WITH MANUFACTURERS SPECIFICATIONS

ALL DOOR HARDWARE/FURNITURE SHALL BE AS SELECTED

WINDOW SIZES NOMINATED ARE NOMINAL ONLY. ACTUAL SIZE MAY VARY ACCORDING TO MANUFACTURER.

ALL WINDOWS & DOORS TO BE INSTALLED & FLASHED ALL AROUND IN STRICT ACCORDANCE TO MANUFACTURERS SPECIFICATIONS & THE BCA & ENERGY RATING REQUIREMENTS.

ROBE & CUPBOARD DOORS SHALL BE ALUMINIUM STEEL FRAMED SLIDING DOORS WITH PAINTED PLASTERBOARD INSERTS UNLESS STATED OTHERWISE IN SCHEDULE

ALL WC DOORS TO COMPY WITH BCA PART 3.8.3.3

GLAZING, INCLUDING SAFETY GLAZING, SHALL BE INSTALLED TO A SIZE, TYPE & THICKNESS SO AS TO COMPLY WITH

-BCA PART 3.6 FOR CLASS 1 AND 10 BUILDINGS WITHIN A DESIGN WIND SPEED OF NOT MORE THAN N3, AND;

-BCA PART B1.4 FOR CLASS 2 TO 9 BUILDINGS

SAFETY GLAZING TO BE USED IN THE FOLLOWING CASES:

ALL ROOMS

- WITHIN 500mm VERTICAL OF FLOOR LEVEL

# BATHROOMS

- WITHIN 1500mm VERTICAL FROM BATH BASE - WITHIN 50mm HORIZONTAL FROM BATH/SHOWER TO SHOWER DOORS, SHOWER SCREENS AND BATH ENCLOSURES

# LAUNDRY

- WITHIN 20mm VERTICAL FROM FLOOR LEVEL AND/OR WITHIN 300mm VERTICAL OF TROUGH AND BATH ENCLOSURES

# DOORWAY

- WITHIN 300mm HORIZONTAL FROM ALL DOORS

- 1. WINDOW GLAZING SHALL COMPLY WITH AS 1288 (2006).
- 2. FOR GLASS LESS THAN 500mm ABOVE FLOOR LEVEL USE ORDINARY ANNEALED GLASS AS FOLLOWS:

-UP TO 0.1msq - 3mm THICK

-0.1 TO 0.3msq - 4mm THICK

-0.3 TO 2.0msq - 5mm THICK

3. OR USE GRADE 'A' SAFETY GLAZING MATERIALS MATERIALS FROM THE GLAZING CODE AS 1288 (2006) 4. FOR SHOWER SCREENS, SHOWER DOORS OR BATH ENCLOSURES USE LAMINATED SAFETY AS FOLLOWS: -UP TO 2.0msq -5.38mm THICK

2.0 TO 3.0msq -6.38mm THICK

-3.0 TO 5.0msq -8.38mm THICK

OR OTHER GRADE 'A' SAFETY GLASS MATERIAL

WINDOW SCHEDULE HEAD HEIGHT 2400 AFL (UNLESS OTHERWISE NOTED)			
No.	ROOM	SIZE	TYPE
W01	STUDIO-WORKSHOP	2140 x 1450	ASW CLEAR REUSED
W02	ENTRY HALL	1500 x 1200	ASW CLEAR NEW
W03	DISABLED WC	600 x 900	AAW OBSCURE REUSED
W04	TEA MAKING FACILITIES	1500 x 1200	ASW CLEAR NEW
W05	STUDIO-WORKSHOP	2140x 1450	ASW CLEAR REUSED
W06	FAMILY	1450 x 1500	ASW CLEAR REUSED
W07	BED 2	1450 x 1500	ASW CLEAR REUSED
W08	ватн	1200 x 900	AAW CLEAR REUSED
W09	BED 1	1500 x 1500	ASW CLEAR REUSED
W10	FAMILY	1500 x 1500	ASW CLEAR NEW
W11	FAMILY	1500 x 1500	ASW CLEAR NEW

	DOOR SCHEDULE HEAD HEIGHT 2400			
	No.	ROOM	SIZE	TYPE
	D01	ENTRY	2 (760 x 2025)	EXTERNAL FULL GLASS DOORS
	D02	ENTRY HALL	820 x 2025	EXTERNAL
	D03	TEA MAKING FACILITIES	860 x 2040	EXTERNAL
Ī	D04	STUDIO-WORKSHOP	2 (760 x 2120)	EXTERNAL FULL GLASS DOORS WITH SIDELIGHT
	D05	STUDIO-WORKSHOP	2 (760 x 2040)	INTERNAL
	D06	DISABLED WC	920 x 2040	INTERNAL
$\Lambda$	D07	STORE ROOM	860 x 2040	INTERNAL
<b>'</b> [	D08	BALCONY	820 x 2100	EXTERNAL
	D09	BALCONY	820 x 2100	EXTERNAL FULL GLASS DOORS
Y	D10	BED 2	820 x 2040	INTERNAL
	D11	WC /	820 x 2040	INTERNAL
	D12	BED 1	820 x 2040	INTERNAL

AFW	ALUMINIUM FIXED WINDOW
AAW	ALUMINIUM AWNING WINDOW
ASW	ALUMINIUM SLIDING WINDOW
ADH	ALUMINIUM DOUBLE HUNG WINDOW
ASH	ALUMINIUM SINGLE HUNG WINDOW
ACW	ALUMINIUM CASEMENT WINDOW
TFW	TIMBER FIXED WINDOW
TAW	TIMBER AWNING WINDOW
TSW	TIMBER SLIDING WINDOW
TDH	TIMBER DOUBLE HUNG WINDOW
TSH	TIMBER SINGLE HUNG WINDOW
TCW	TIMBER CASEMENT WINDOW

CLIENT:
MICHAEL VELONAKIS
PROPOSED:
PROPOSED B&B TOURIST
ACCOMMODATION AND EXISTING
RESIDENCE
SITE ADDRESS:
31 CRESCENT DRIVE
NORTON SUMMIT
DATE: JUNE 2024
DRAWN: GR
SHEET: 14 OF 16
JOB No.




PHONE: 0419851867 WEBSITE: www.diamantidesign.com.au EMAIL: jim@diamantidd.com.au


THESE DESIGNS ARE COPYRIGHT. LEGAL ACTION WILL BE TAKEN AGAINST ANY INFRINGEMENT IN PART OR WHOLE UNLESS WRITTEN AUTHORITY IS GIVEN BY THE DESIGNER.

FIGURED DIMENSIONS SHALL TAKE PREFERENCE OVER SCALED DRAWINGS. VERIFY DIMENSIONS AND LEVELS BEFORE COMMENCING ANY BULDING WORK. ANY DISCREPANCY TO BE DEPORTED TO THE DESIGNERS IMMEDIATELY


# FOR CONSTRUCTION JUNE 24

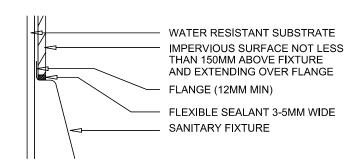




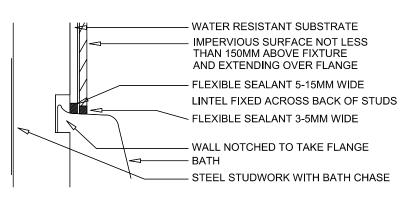


**BATH CHASE DETAIL** 

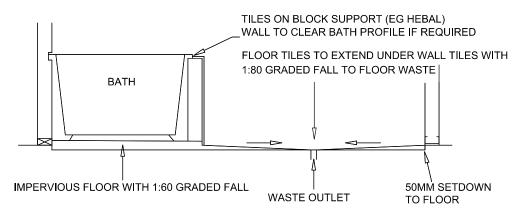


FLOOR GRADES TO WASTE OULETS

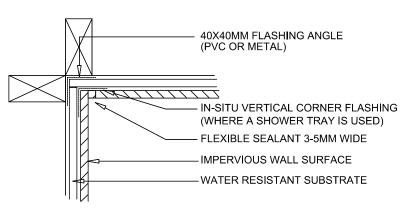

WALL JUNCTION

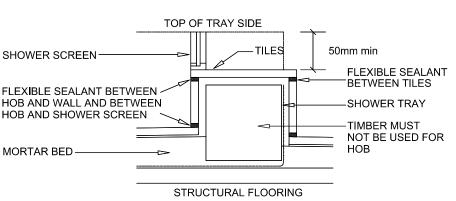


HOB AT SHOWER TRAY

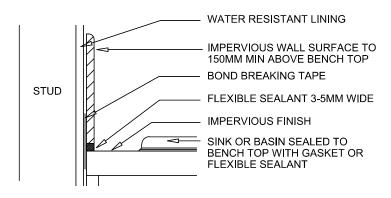

WALL AND BENCH TOP JUNCTION WITH INSET FIXTURE

NOGGING TO FIX BOTTOM WATER RESISTANT SUBSTRATE OF WALL LINING WATER RESISTANT LINING VERTICAL CORNER FLASHING ANGLE SHOWER TRAY FLEXIBLE SEALANT (3 - 5MM WIDE) FLOOR TILES FALL 1:60 15mm MIN TO FLOOR WASTE CEMENT SAND MORTAR BED CONCRETE RECESS OR HOB SHOWER TRAY ADHERED CAST INTEGRALLY WITH SLAB TO FLOOR ONLY WATERPROOFING OF SHOWER WALL AND FLOOR JUNCTIONS

WET AREA DETAILS

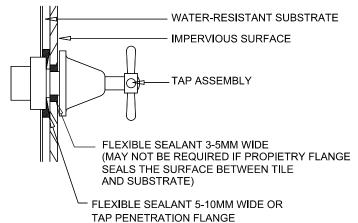

# PENETRATIONS THROUGH WALLS

# IN SHOWER AREAS

#### WET AREA NOTATIONS

TO COMPLY WITH VOLUME TWO OF BCA 2015. REQUIREMENTS OF BCA PART 3.8.1 (Wet Areas)

SHOWER AREA (Cat. 1) FLOOR - IMPERVIOUS WITH SHOWER TRAY OR BASE

DRAINAGE - 1:60 MIN GRADE TO SHOWER TRAP. SHOWER TRAYS DRAINED TO FLANGE IN

SHOWER TRAP BATH AND LAUNDRY FLOOR - IMPERVIOUS

DRAINAGE - BATH - 1:80 MIN TO FLOOR TRAP. MAY BE DRAINED TO SHOWER TRAP

WHERE HOB NOT USED.

DRAINAGE - LDRY - 1:80 MIN TO TRAP SINGLE ROOM CONTAINING WC

FLOOR - IMPERVIOUS **DRAINAGE - NO REQUIREMENT** 

NOTE: FLOORING TO BE OF IMPERVIOUS FLOOR

SHEETING OR SIMILAR APPROVED FLOORING AS

INSTALLATION OF PREFORMED SHOWER BASES SHALL COMPLY WITH THE REQUIREMENTS OF THE MANUFACTURERS SPECIFICATIONS, ANY ALTERNATIVE WATERPROOFING SYSTEM SHALL BE AN ACCREDITTED INSTALLATION SYSTEM IN ACCORDANCE WITH THE MANUFACTURERS'

ADELAIDE HILLS COUNCIL **RECEIVED 27/08/2024** 

CLIENT: MICHAEL VELONAKIS PROPOSED: PROPOSED B&B TOURIST ACCOMMODATION AND EXISTING RESIDENCE SITE ADDRESS 31 CRESCENT DRIVE NORTON SUMMIT DATE: JUNE 2024 DRAWN: GR SHEET: 15 OF 16 JOB No.



GIVEN BY THE DESIGNER.

PO Box 551, Marleston SA, 5033 PHONE: 0419851867 WEBSITE: www.diamantidesign.com.au

THESE DESIGNS ARE COPYRIGHT. LEGAL ACTION WILL BE TAKEN AGAINST ANY INFRINGEMENT IN PART OR WHOLE UNLESS WRITTEN AUTHORITY IS

EMAIL: jim@diamantidd.com.au

FIGURED DIMENSIONS SHALL TAKE PREFERENCE OVER SCALED DRAWINGS. VERIFY DIMENSIONS AND LEVELS BEFORE COMMENCING ANY BUILDING WORK. ANY DISCREPANCY TO BE REPORTED TO THE DESIGNERS IMMEDIATELY.

# WEATHER BOARD CLADDING TO LOWER FLOOR

All bracing capacities up to 2700mm high walls. For walls over 2700mm

refer to page 145 table 8.19 of

30 X 0.8MM METAL STRAP

LOOPED OVER PLATE AND

FIXED TO STUD WITH

FLATHEAD NAILS TO


4/30 X 2.8MM

EACH END

ORB CLADDING TO UPPER FLOOR

TYPE A BRACING (1.5kN/m) METAL ANGLE BRACE. THE MAXIMUM DEPTH OF SAW CUT NOT TO EXCEED 20mm

> Metal angle brace of min. nominal section 18x16x1.2mm

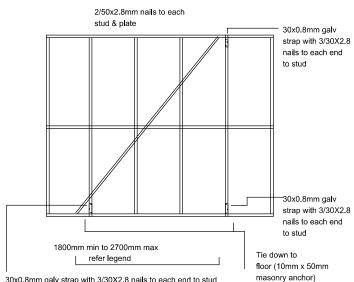

# TYPE A HARDBOARD BRACING (6.4mm) 3.4kN/m

P.9 3.0 kn (2 type A top fixings) or (1 type D (a) top fixing)

P1.2 4.0 kn (2 type A top fixings) or (1 type D (b) top fixing)

1.8 (2.7kn) (2 type A top fixings) or (3 type C top fixings)


2.1 (3.1kn) (2 type A top fixings) or (3 type C top fixings)

2.4 (3.6kn) (2 type A top fixings) or (4 type C top fixings) 2.7 (4.0kn) (2 type A top fixings)

or (4 type C top fixings)

Hardboard shall be nailed to frame using minimum 25x2.8mm galvanised nails or equivalent.

Nails shall be located a minimum of 10mm from the vertical edges and 20mm from the top and bottom edges panel edges shall be supported by stude

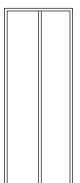


Fastener spacing top plate 100mm bot plate 100mm vertical edges 100mm intermediate studs 300mm

Tie down to slab 10mm x 50mm masonry anchor to each side of bracing panel

# TYPE B BRACING (3.0kN/m)

DOUBLE DIAGONAL TENSION BRACE

30 x 0.8mm tensioned galv. metal straps nailed to plates with 4/30 x 2.8 mm galv flathead nails to each end

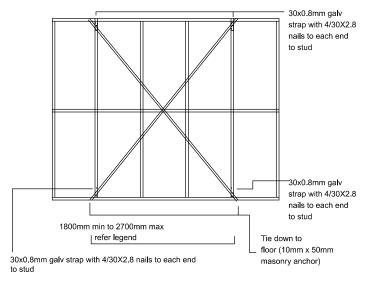

### TYPE B HARDBOARD BRACING (6.4mm) 6.0kN/m

P.9 5.4 kN (1 type B top fixing) or (2 type D (a) top fixings)

P1.2 7.2 kN (1 type B top fixing) or (2 type D (a) top fixings)

P.6 2.7 kN (1 type B top fixing) or (1 type D (a) top fixing) with M10 x 50mm coachscrew

B P.45 2.7 kN (1 type B top fixing)

or (1 type D (a) top fixing) with M10 x 50mm coachscrew & 38x38 sq. washer to each corner

& 38x38 sq. washer to each corner

В

1.8 (5.4kN) (1 type B top fixing)

or (2 type D (a) top fixings) 2.1 (6.3kN) (1 type B top fixing)

or (2 type D (a) top fixings) 2.4 (7.2kN) (1 type B top fixing)

or (2 type D (a) top fixings)

2.7 (8.1kN) (1 type B top fixing) or (2 type D (a) top fixings)

Hardboard shall be nailed to frame using minimum 30x2.8mm galvanised nails or equivalent Nails shall be located a minimum of 10mm from the vertical edges and 15mm from the top and

bottom edges panel edges shall be supported

#### STANDARD FIXING & TIE-DOWN REQUIREMENTS

#### 28 m/s SHEET ROOF

BOTTOM PLATES TO CONCRETE SLABS INCLUDING WALLS WITH TYPE A BRACES:

- 1/75 mm MASONRY NAIL AT MAX 1200 C

BOTTOM PLATES TO CONCRETE SLAB FOR WALLS WITH TYPE B BRACES:

- ADDITIONAL 1/M10 BOLTS OR EQUIVALENT MASONRY ANCHOR AT EACH END OF BRACING UNIT (MAX, 1200 mm C)

NOTE: THESE FIXINGS ARE ONLY REQUIRED TO TIE DOWN BRACED PANELS.

#### BOTTOM PLATES TO STUDS:

- 2/75 mm NAILS AT MAXIMUM 600 mm C FOR PLATES TO 38 mm THICK

- 2/90 mm NAILS AT MAXIMUM 600 mm C FOR PLATES TO 50 mm THICK BOTTOM PLATES TO STUDS:

- 2/75 mm NAILS AT MAXIMUM 600 mm C FOR PLATES TO 38 mm THICK

- 2/90 mm NAILS AT MAXIMUM 600 mm C FOR PLATES TO 50 mm THICK

- ADDITIONAL 30 X 0.8 mm G.I. STRAP FIXED WITH 3/25 X 2.5 mm NAILS

INTO THE SIDE OF EACH MEMBER NOTE: MAX. TIE DOWN SPACING SHALL BE 1800 mm OR THREE STUD SPACINGS WHICHEVER IS THE LESSER TO A MAX. TIE DOWN DISTANCE OF 6000 mm

FOR TIE-DOWN DISTANCE OVER 6000 mm A TIE-DOWN IS REQUIRED FOR EACH MEMBER

#### RAFTERS TO TOP PLATES:

- 2/75 mm SKEW NAILS

- ADDITIONAL 30 X 0.8 G.I. STRAP FIXED WITH 3/25 X 2.5 mm NAILS

INTO THE SIDE OF EACH MEMBER NOTE: MAX. TIE DOWN SPACING SHALL BE 1800 mm OR THREE STUD SPACINGS WHICHEVER IS THE LESSER TO A MAX. TIE DOWN DISTANCE OF 6000 mm FOR TIE-DOWN DISTANCE OVER 6000 mm A TIE-DOWN IS REQUIRED FOR EACH MEMBER

#### SECONDARY TOP PLATES (RIBBON PLATES TO TOP PLATES):

- 2/75 mm NAILS AT MAXIMUM 600 mm C FOR PLATES TO 38 mm THICK

- 2/90 mm NAILS AT MAXIMUM 600 mm C FOR PLATES TO 50 mm THICK

### ROOF TRUSSES TO TOP PLATES:

- IN A/W MANUFACTURES RECOMMENDATIONS (GENERALLY 1 FRAMING ANCHOR)

- ADDITIONAL ROOF TRUSS TIE-DOWN IN A/W TIE DOWN REQUIRED FOR CONVENTIONAL ROOFS

#### ROOF PURLINS TO RAFTERS

- FOR A SHEET ROOF WITH RAFTER SPACING OF 1200 mm, 2/75 GROOVED ANNULAR NAILS SKEW NAILED

#### COLLAR TIES:

- TO 4.2 m LONG, 2/75 mm NAILS EACH END

- OVER 4.2 m LONG, 1 M10 BOLT EACH END

Fastener spacing top plate 50mm bot plate 50mm vertical edges 100mm intermediate studs 300mm

Tie down to slab

bracing panel

2/10mm x 50mm masonr

anchors to each side of

CLIENT: MICHAEL VELONAKIS PROPOSED:

PROPOSED B&B TOURIST ACCOMMODATION AND EXISTING

RESIDENCE SITE ADDRESS

FOR CONSTRUCTION JUNE 24

31 CRESCENT DRIVE NORTON SUMMIT DATE: JUNE 2024

DRAWN: GR SHEET: 16 OF 16

JOB No.



PO Box 551, Marleston SA, 5033

PHONE: 0419851867 WEBSITE: www.diamantidesign.com.au EMAIL: jim@diamantidd.com.au

THESE DESIGNS ARE COPYRIGHT. LEGAL ACTION WILL BE TAKEN AGAINST ANY INFRINGEMENT IN PART OR WHOLE UNLESS WRITTEN AUTHORITY IS GIVEN BY THE DESIGNER.

FIGURED DIMENSIONS SHALL TAKE PREFERENCE AND LEVELS BEFORE COMMENCING ANY BUILDING WORK. ANY DISCREPANCY TO BE REPORTED TO THE DESIGNERS IMMEDIATELY.

**BRACING DETAILS** 

ADELAIDE HILLS COUNCIL **RECEIVED 27/08/2024** 

REFER TO APPENDIX G AS 1684 2-1999 TO OBTAIN DETAILS OF FIXINGS

TIE-DOWN CONNECTIONS ARE CONTINUED THROUGH TO A LOWER MEMBER

REFERRED TO. INTERMEDIATE TIE-DOWN IS NOT REQUIRED WHERE







Scale = 1:1250

50 m

DISCLAIMER
Apart from any use permitted under the Copyright Act 1968, no part
may be reproduced by any process without prior written permission
obtained from the Adelaide Hills Council. Requests and enquiries
concerning reproduction and rights should be directed to the Chief
Executive Officer, The Adelaide Hills Council, PO Box 44, Woodside

SA 5244.The Adelaide Hills Council, its employees and servants do not warrant or make any representations regarding the use, or results of use of the information contained herein to its correctness, accuracy, currency or otherwise. In particular, it should be noted that the accuracy of property boundaries when displayed over aerial photography cannot be considered to be accurate, and that the only certain method of determining boundary locations is to use the


services of a licensed Surveyor. The Adelaide Hills Council, its employees & servants expressly disclaim all liability or responsibility to any person using the information or advice contained herein.  $\ensuremath{\mathbb{C}}$ 

22-Oct-2024

# **SAPPA Report**

The SA Property and Planning Atlas is available on the Plan SA website: https://sappa.plan.sa.gov.au

# Zoning Map

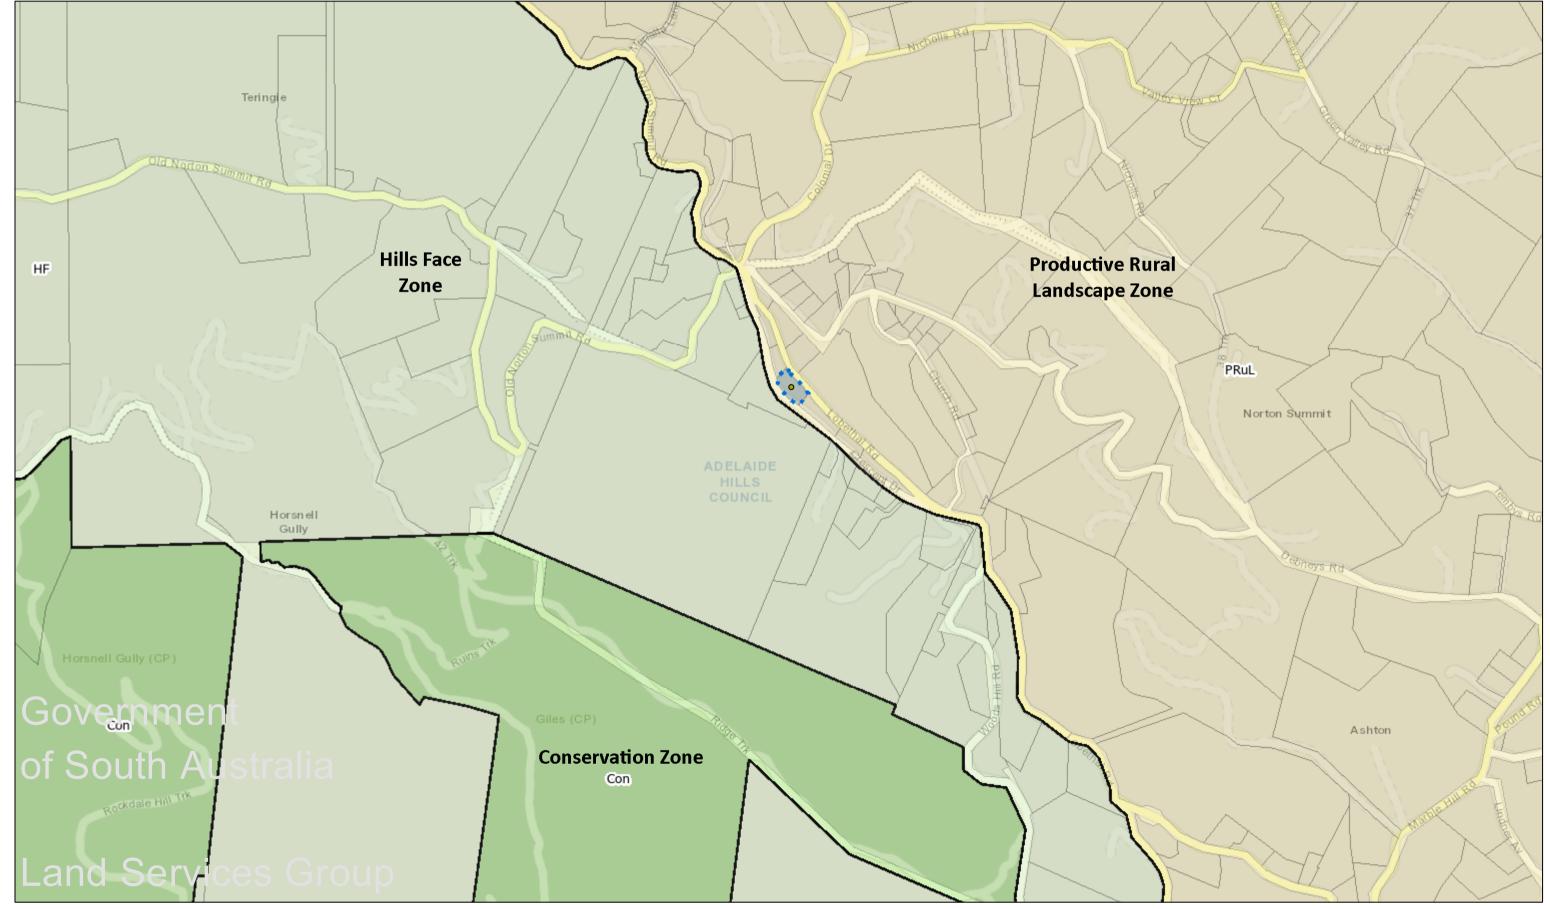

**Disclaimer:** The information provided above, is not represented to be accurate, current or complete at the time of printing this report. The Government of South Australia accepts no liability for the use of this data, or any reliance placed on it.

### Address: 31 CRESCENT DR NORTON SUMMIT SA 5136

To view a detailed interactive property map in SAPPA click on the map below



### **Property Zoning Details**

#### Zone

Productive Rural Landscape

#### Overlay

**Environment and Food Production Area** 

Hazards (Bushfire - High Risk)

Heritage Adjacency

Hazards (Flooding - Evidence Required)

Limited Land Division Native Vegetation

Prescribed Wells Area

Traffic Generating Development

**Urban Transport Routes** 

# Selected Development(s)

_			
$\neg$	$\sim$		L
. ,	$\vdash$	(	ĸ

This development may be subject to multiple assessment pathways. Please review the document below to determine which pathway may be applicable based on the proposed development compliances to standards.

If no assessment pathway is shown this mean the proposed development will default to performance assessed. Please contact your local council in this instance. Refer to Part 1 - Rules of Interpretation - Determination of Classes of Development

Deck - Code Assessed - Performance Assessed

# Part 2 - Zones and Sub Zones

# Productive Rural Landscape Zone

# **Assessment Provisions (AP)**

Desired Outcome (DO)

Desired Outcome		
DO 1	A diverse range of land uses at an appropriate scale and intensity that	
	capitalise on the region's proximity to the metropolitan area and the tourist	
	and lifestyle opportunities this presents while also conserving the natural and	
	rural character, identity, biodiversity and sensitive environmental areas and	
	scenic qualities of the landscape.	

Policy24	P&D Code (in effect) Version 2024.17 12/9/2024
DO 2	A zone that promotes agriculture, horticulture, value adding opportunities, farm gate businesses, the sale and consumption of agricultural based products, tourist development and accommodation that expands the economic base and promotes its regional identity.
DO 3	Create local conditions that support new and continuing investment while seeking to promote co-existence with adjoining activities and mitigate land use conflicts.

Performance Outcomes (PO) and Deemed to Satisfy (DTS) / Designated Performance Feature (DPF) Criteria

Performance Outcome	Deemed-to-Satisfy Criteria / Designated Performance Feature
Siting ar	nd Design
PO 2.2 Buildings are generally located on flat land to minimise cut and fill and the associated visual impacts.	DTS/DPF 2.2  Buildings:  (a) are located on a site with a slope not greater than 10% (1-in-10)  (b) do not result excavation and/or filling of land that is greater than 1.5m from natural ground level.

# Table 5 - Procedural Matters (PM) - Notification

The following table identifies, pursuant to section 107(6) of the *Planning, Development and Infrastructure Act 2016*, classes of performance assessed development that are excluded from notification. The table also identifies any exemptions to the placement of notices when notification is required.

#### Interpretation

Notification tables exclude the classes of development listed in Column A from notification provided that they do not fall within a corresponding exclusion prescribed in Column B.

Where a development or an element of a development falls within more than one class of development listed in Column A, it will be excluded from notification if it is excluded (in its entirety) under any of those classes of development. It need not be excluded under all applicable classes of development.

Where a development involves multiple performance assessed elements, all performance assessed elements will require notification (regardless of whether one or more elements are excluded in the applicable notification table) unless every performance assessed element of the application is excluded in the applicable notification table, in which case the application will not require notification.

A relevant authority may determine that a variation to 1 or more corresponding exclusions prescribed in Column B is minor in nature and does not require notification.

Class of Development	Exceptions
(Column A)	(Column B)
<ol> <li>Development which, in the opinion of the relevant authority, is of a minor nature only and will not unreasonably impact on the owners or occupiers of land in the locality of the site of the development.</li> </ol>	
<ul> <li>2. Any development involving any of the following (or of any combination of any of the following): <ul> <li>(a) advertisement</li> <li>(b) agricultural building</li> <li>(c) air handling unit, air conditioning system or exhaust fan</li> <li>(d) ancillary accommodation</li> <li>(e) carport</li> <li>(f) deck</li> <li>(g) fence</li> <li>(h) dwelling</li> <li>(i) dwelling addition</li> <li>(j) farming</li> <li>(k) horse keeping</li> <li>(l) internal building work</li> <li>(m) land division</li> <li>(n) outbuilding</li> </ul> </li> </ul>	None specified.
<ul> <li>(n) outbuilding</li> <li>(o) pergola</li> <li>(p) private bushfire shelter</li> <li>(q) protective tree netting structure</li> </ul>	

Policy24	P&D Code (in effect) Version 2024.17 12/9/2024
(r) replacement building	
(s) retaining wall	
(t) solar photovoltaic panels (roof mounted)	
(u) shade sail	
(v) swimming pool or spa pool and associated swimming pool safety features	
(w) temporary accommodation in an area affected by bushfire	
(x) tree damaging activity	
(y) verandah	
(z) water tank.	
C, Hard dam	
<ol> <li>Any development involving any of the following (or of any combination of any of the following):</li> </ol>	Except development that does not satisfy any of the following:
(a) industry	1. Productive Rural Landscape Zone DTS/DPF 4.1
(b) store	2. Productive Rural Landscape Zone DTS/DPF 4.3.
(c) warehouse.	
4. Demolition.	Except any of the following:
	the demolition (or partial demolition) of a State or Local Heritage     Place (other than an excluded building)
	the demolition (or partial demolition) of a building in a Historic Area
	Overlay (other than an excluded building).
5. Function venue within The Cedars Subzone.	None specified.
6. Function venue.	Except function venue that does not satisfy Productive Rural Landscape Zone DTS/DPF 6.6.
7. Horticulture.	Except horticulture that does not satisfy any of the following:
	Productive Rural Landscape Zone DTS/DPF 3.1(d)
	2. Productive Rural Landscape Zone DTS/DPF 3.1(e).
	·
8. Railway line.	Except where located outside of a rail corridor or rail reserve.
9. Shop within The Cedars Subzone.	None specified.
10. Shop.	Except shop that does not satisfy any of the following:
	Productive Rural Landscape Zone DTS/DPF 6.1
	2. Productive Rural Landscape Zone DTS/DPF 6.2.
	·
11. Tourist accommodation within The Cedars Subzone.	None specified.
12. Tourist accommodation.	Except tourist accommodation that does not to satisfy any of the following:
	1. Productive Rural Landscape Zone DTS/DPF 6.3
	2. Productive Rural Landscape Zone DTS/DPF 6.4.
	· ·

# Placement of Notices - Exemptions for Performance Assessed Development

Pursuant to regulation 47(6)(c) of the Planning, Development and Infrastructure (General) Regulations 2017, the requirement to place a notice on the relevant land under section 107(3)(a)(ii) of the *Planning, Development and Infrastructure Act 2016* does not apply in the Productive Rural Landscape Zone.

# Placement of Notices - Exemptions for Restricted Development

Pursuant to regulation 47(6)(c) of the Planning, Development and Infrastructure (General) Regulations 2017, the requirement to place a notice on the relevant land under section 110(2)(a)(iv) of the *Planning, Development and Infrastructure Act 2016* does not apply in the Productive Rural Landscape Zone.

# Part 3 - Overlays

# Hazards (Bushfire - High Risk) Overlay

# **Assessment Provisions (AP)**

Desired Outcome (DO)

	Desired Outcome
DO 1	Development, including land division is sited and designed to minimise the threat and impact of bushfires on life and property with regard to the following risks:
	(a) potential for uncontrolled bushfire events taking into account the increased frequency and intensity of bushfires as a result of climate change
	(b) high levels and exposure to ember attack
	(c) impact from burning debris
	(d) radiant heat
	(e) likelihood and direct exposure to flames from a fire front.
DO 2	Activities that increase the number of people living and working in the area or where evacuation would be difficult is sited away from areas of unacceptable bushfire risk.
DO 3	To facilitate access for emergency service vehicles to aid the protection of lives and assets from bushfire danger.

Performance Outcomes (PO) and Deemed-to-Satisfy (DTS) Criteria / Designated Performance Feature (DPF)

Performance Outcome	Deemed-to-Satisfy Criteria / Designated Performance Feature
Lan	d Use
PO 1.1	DTS/DPF 1.1
Development that significantly increases the potential for fire outbreak as a result of the spontaneous combustion of materials, spark generation or through the magnification and reflection of light is not located in areas of unacceptable bushfire risk.	None are applicable.
Sil	ing
PO 2.1	DTS/DPF 2.1
Buildings and structures are located away from areas that pose an unacceptable bushfire risk as a result of vegetation cover and type, and terrain.	None are applicable.
Built	Form
PO 3.1	DTS/DPF 3.1
Buildings and structures are designed and configured to reduce the impact of bushfire through using designs that reduce the potential for trapping burning debris against or underneath the building or structure, or between the ground and building floor level in the case of transportable buildings and buildings on stilts.	None are applicable.
PO 3.2	DTS/DPF 3.2
Extensions to buildings, outbuildings and other ancillary structures are sited and constructed using materials to minimise the threat of fire spread to residential and tourist accommodation (including boarding houses, hostels, dormitory style accommodation, student accommodation and Workers' accommodation) in the event of bushfire.	Outbuildings and other ancillary structures are sited no closer than 6m from the habitable building.

# Procedural Matters (PM) - Referrals

The following table identifies classes of development / activities that require referral in this Overlay and the applicable referral body. It sets out the purpose of the referral as well as the relevant statutory reference from Schedule 9 of the Planning, Development and Infrastructure (General) Regulations 2017.

Policy24		P	&D Code (in effect) Ver	sion 2024.17 12/9/2024
planning co	relevant certificate accompanies the application for onsent in respect of the development, any of the lasses of development (including alterations and which increase the floor area of such buildings by 10%	South Australian Country Fire Service.	To provide expert assessment and direction to the relevant authority on the potential impacts of bushfire on the	Development of a class to which Schedule 9 clause 3 item 2 of the Planning, Development and Infrastructure (General) Regulations 2017 applies.
(a)	land division creating one or more additional allotments		development.	
(b)	dwelling			
(c)	ancillary accommodation			
(d)	residential flat building			
(e)	tourist accommodation			
(f)	boarding home			
(g)	dormitory style accommodation			
(h)	workers' accommodation			
(i)	student accommodation			
(j)	child care facility			
(k)	educational facility			
(l)	retirement village			
(m)	supported accommodation			
(n)	residential park			
(0)	hospital			
(p)	camp ground.			

# **Native Vegetation Overlay**

# Assessment Provisions (AP)

Desired Outcome (DO)

Desired Outcome		
	Areas of native vegetation are protected, retained and restored in order to	
	sustain biodiversity, threatened species and vegetation communities, fauna	
	habitat, ecosystem services, carbon storage and amenity values.	

Performance Outcomes (PO) and Deemed-to-Satisfy (DTS) Criteria / Designated Performance Feature (DPF)

Performance Outcome	Deemed-to-Satisfy Criteria / Designated Performance Feature		
Environmental Protection			
PO 1.1	DTS/DPF 1.1		
Development avoids, or where it cannot be practically avoided, minimises the clearance of native vegetation taking into account the siting of buildings, access points, bushfire protection measures and building maintenance.	An application is accompanied by:  (a) a declaration stating that the proposal will not, or would not, involve clearance of native vegetation under the Native Vegetation Act 1991, including any clearance that may occur:  (i) in connection with a relevant access point and / or driveway  (ii) within 10m of a building (other than a residential building or tourist accommodation)  (iii) within 20m of a dwelling or addition to an existing dwelling for fire prevention and control  (iv) within 50m of residential or tourist accommodation in connection with a requirement under a relevant overlay to establish an asset protection zone in a bushfire prone area  or  (b) a report prepared in accordance with Regulation 18(2)(a) of the Native Vegetation Regulations 2017 that establishes that the clearance is categorised as 'Level 1 clearance'.		
PO 1.2	DTS/DPF 1.2		
Native vegetation clearance in association with development avoids the following:	None are applicable.		
(a) significant wildlife habitat and movement corridors			

Policy24		P&D Code (in effect) Version 2024.17 12/9/2024
(b)	rare, vulnerable or endangered plants species	
(c)	native vegetation that is significant because it is located in an area which has been extensively cleared	
(d)	native vegetation that is growing in, or in association with, a wetland environment.	

# Procedural Matters (PM) - Referrals

The following table identifies classes of development / activities that require referral in this Overlay and the applicable referral body. It sets out the purpose of the referral as well as the relevant statutory reference from Schedule 9 of the Planning, Development and Infrastructure (General) Regulations 2017.

Class of Development / Activity	Referral Body	Purpose of Referral	Statutory Reference
Development that is the subject of a report prepared in accordance with Regulation 18(2)(a) of the <i>Native Vegetation Regulations 2017</i> that categorises the clearance, or potential clearance, as 'Level 3 clearance' or 'Level 4 clearance'.	Native Vegetation Council	To provide expert assessment and direction to the relevant authority on the potential impacts of development on native vegetation.	Development of a class to which Schedule 9 clause 3 item 11 of the Planning, Development and Infrastructure (General) Regulations 2017 applies.

# Part 4 - General Development Policies

# Clearance from Overhead Powerlines

# Assessment Provisions (AP)

Desired Outcome (DO)

Desired Outcome		
DO 1	Protection of human health and safety when undertaking development in the	
	vicinity of overhead transmission powerlines.	

Performance Outcomes (PO) and Deemed-to-Satisfy (DTS) Criteria / Designated Performance Feature (DPF)

Performance Outcome	Deemed-to-Satisfy Criteria / Designated Performance Feature
PO 1.1	DTS/DPF 1.1
Buildings are adequately separated from aboveground powerlines to minimise potential hazard to people and property.	(a) a declaration is provided by or on behalf of the applicant to the effect that the proposal would not be contrary to the regulations prescribed for the purposes of section 86 of the Electricity Act 1996     (b) there are no aboveground powerlines adjoining the site that are the subject of the proposed development.

# Design

# Assessment Provisions (AP)

Desired Outcome (DO)

Desired Outcome		
DO 1	Development is:	
	(a) contextual - by considering, recognising and carefully responding to its natural surroundings or built environment and positively contributes to the character of the immediate area  (b) durable - fit for purpose, adaptable and long lasting	

Policy24	P&D Code (in effect) Version 2024.17 12/9/2024
	(c) inclusive - by integrating landscape design to optimise pedestrian and cyclist usability, privacy and equitable access, and promoting the provision of quality spaces integrated with the public realm that can be used for access and recreation and help optimise security and safety both internally and within the public realm, for occupants and visitors
	(d) sustainable - by integrating sustainable techniques into the design and siting of development and landscaping to improve community health, urban heat, water management, environmental performance, biodiversity and local amenity and to minimise energy consumption.

Performance Outcome	Deemed-to-Satisfy Criteria / Designated Performance Feature
	velopment
	and sloping land
PO 8.1 Development, including any associated driveways and access tracks, minimises the need for earthworks to limit disturbance to natural topography.	DTS/DPF 8.1  Development does not involve any of the following:
	·
	(a) excavation exceeding a vertical height of 1m
	(b) filling exceeding a vertical height of 1m
	(c) a total combined excavation and filling vertical height of 2m or more.
De	Decks
•	and Siting
33.1 ecks are designed and sited to:	DTS/DPF 33.1 Decks:
(a) complement the associated building form	(a) where ancillary to a dwelling:
<ul> <li>(b) minimise impacts on the streetscape through siting behind the building line of the principal building (unless on a significant allotment or open space)</li> <li>(c) minimise cut and fill and overall massing when viewed from adjacent land.</li> </ul>	(ii) are not constructed, added to or altered so that an part is situated:  A. in front of any part of the building line of the dwelling to which it is ancillary or  B. within 900mm of a boundary of the allotment with a secondary street (if the land has boundaries on two or more roads)  (iii) are set back at least 900mm from side or rear allotment boundaries  when attached to the dwelling, has a finished floor level consistent with the finished ground floor level the dwelling  (iv) where associated with a residential use, retains a training area of soft landscaping for the entire development site, including any common property, with a minime dimension of 700mm in accordance with (A) or (B), whichever is less:  A. a total area is determined by the following table:  Site area (or in the case of residential flat building or group dwelling(s), average site area) (m²)

on 13/9/2024 Generated By Policy24

Downloaded on 13/9/2024

>200-450

the amount of existing soft landscaping prior to the development occurring.

Page 7 of 9

>450

В.

where in association with a non-residential use:

Policy24	P&D Code (in effect) Version 2024.17 12/9/2024
	(i) are set back at least 2 metres from the boundary of an allotment used for residential purposes.  (ii) are set back at least 2 metres from a public road.  (iii) have a floor area not exceeding 25m <sup>2</sup> (c) in all cases, has a finished floor level not exceeding 1 metre above natural ground level at any point.
PO 33.2  Decks are designed and sited to minimise direct overlooking of habitable rooms and private open spaces of adjoining residential uses in neighbourhood-type zones through suitable floor levels, screening and siting taking into account the slope of the subject land, existing vegetation on the subject land, and fencing.	DTS/DPF 33.2  Decks with a finished floor level/s 500mm or more above natural ground level facing side or rear boundaries shared with a residential use in a neighbourhood-type zone incorporate screening with a maximum of 25% transparency/openings, permanently fixed to the outer edge of the deck not less than 1.5 m above the finished floor level/s.
PO 33.3  Decks used for outdoor dining, entertainment or other commercial uses provide carparking in accordance with the primary use of the deck.	DTS/DPF 33.3  Decks used for commercial purposes do not result in less on-site car parking for the primary use of the subject land than specified in Transport, Access and Parking Table 1 - General Off-Street Car Parking Requirements or Table 2 - Off-Street Car Parking Requirements in Designated Areas.

# Infrastructure and Renewable Energy Facilities

# Assessment Provisions (AP)

Desired Outcome (DO)

Desired Outcome		
DO 1	Efficient provision of infrastructure networks and services, renewable energy	
	facilities and ancillary development in a manner that minimises hazard, is	
	environmentally and culturally sensitive and manages adverse visual impacts	
	on natural and rural landscapes and residential amenity.	

Performance Outcomes (PO) and Deemed-to-Satisfy (DTS) Criteria / Designated Performance Feature (DPF)

Performance Outcome	Deemed-to-Satisfy Criteria / Designated Performance Feature	
Wastewater Services		
PO 12.2 Effluent drainage fields and other wastewater disposal areas are maintained to ensure the effective operation of waste systems and minimise risks to human health and the environment.	DTS/DPF 12.2  Development is not built on, or encroaches within, an area that is, or will be, required for a sewerage system or waste control system.	